Master Bedroom Suite and Basement Addition

12 Brook Hollow Road, West Tisbury, MA 02575





#### GONZALEZ ARCHITECTS

14 NE 1st Avenue, Suite 507 Miami, FL 33132 305.455.4216

Martha's Vineyard Engineering and Design

79 Beach Road Vineyard Haven, MA 02568 774.563.8535

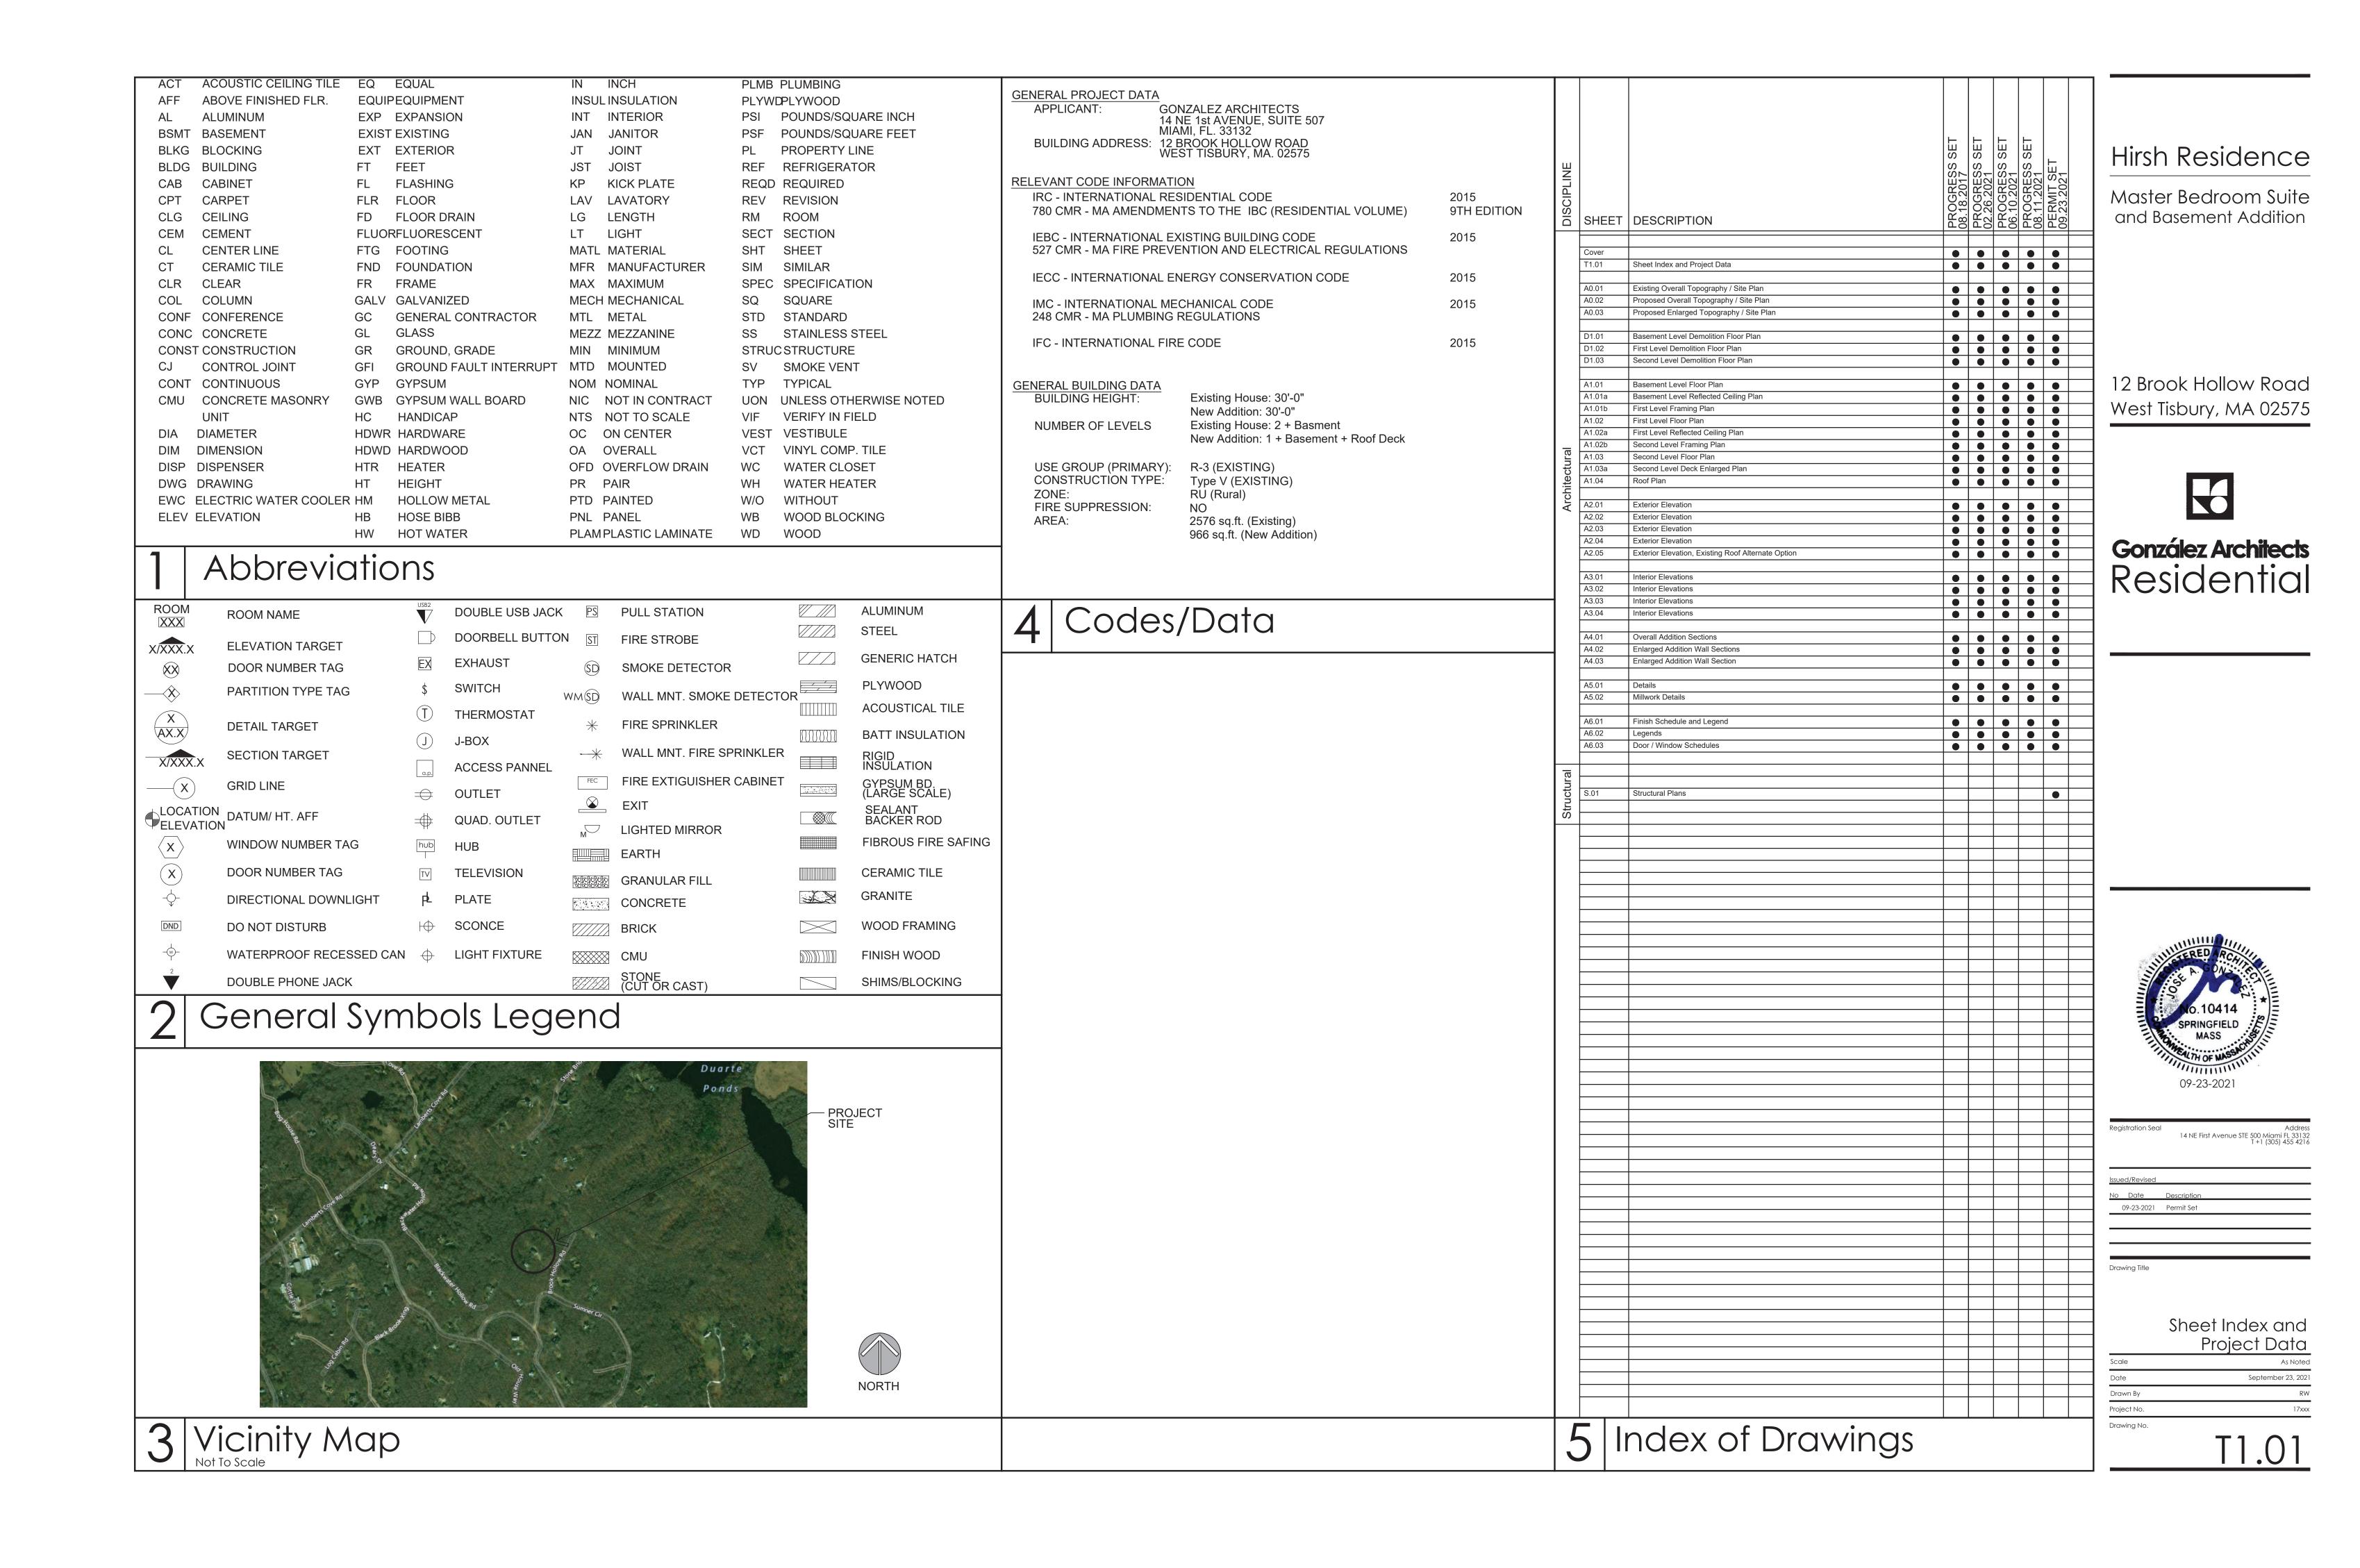

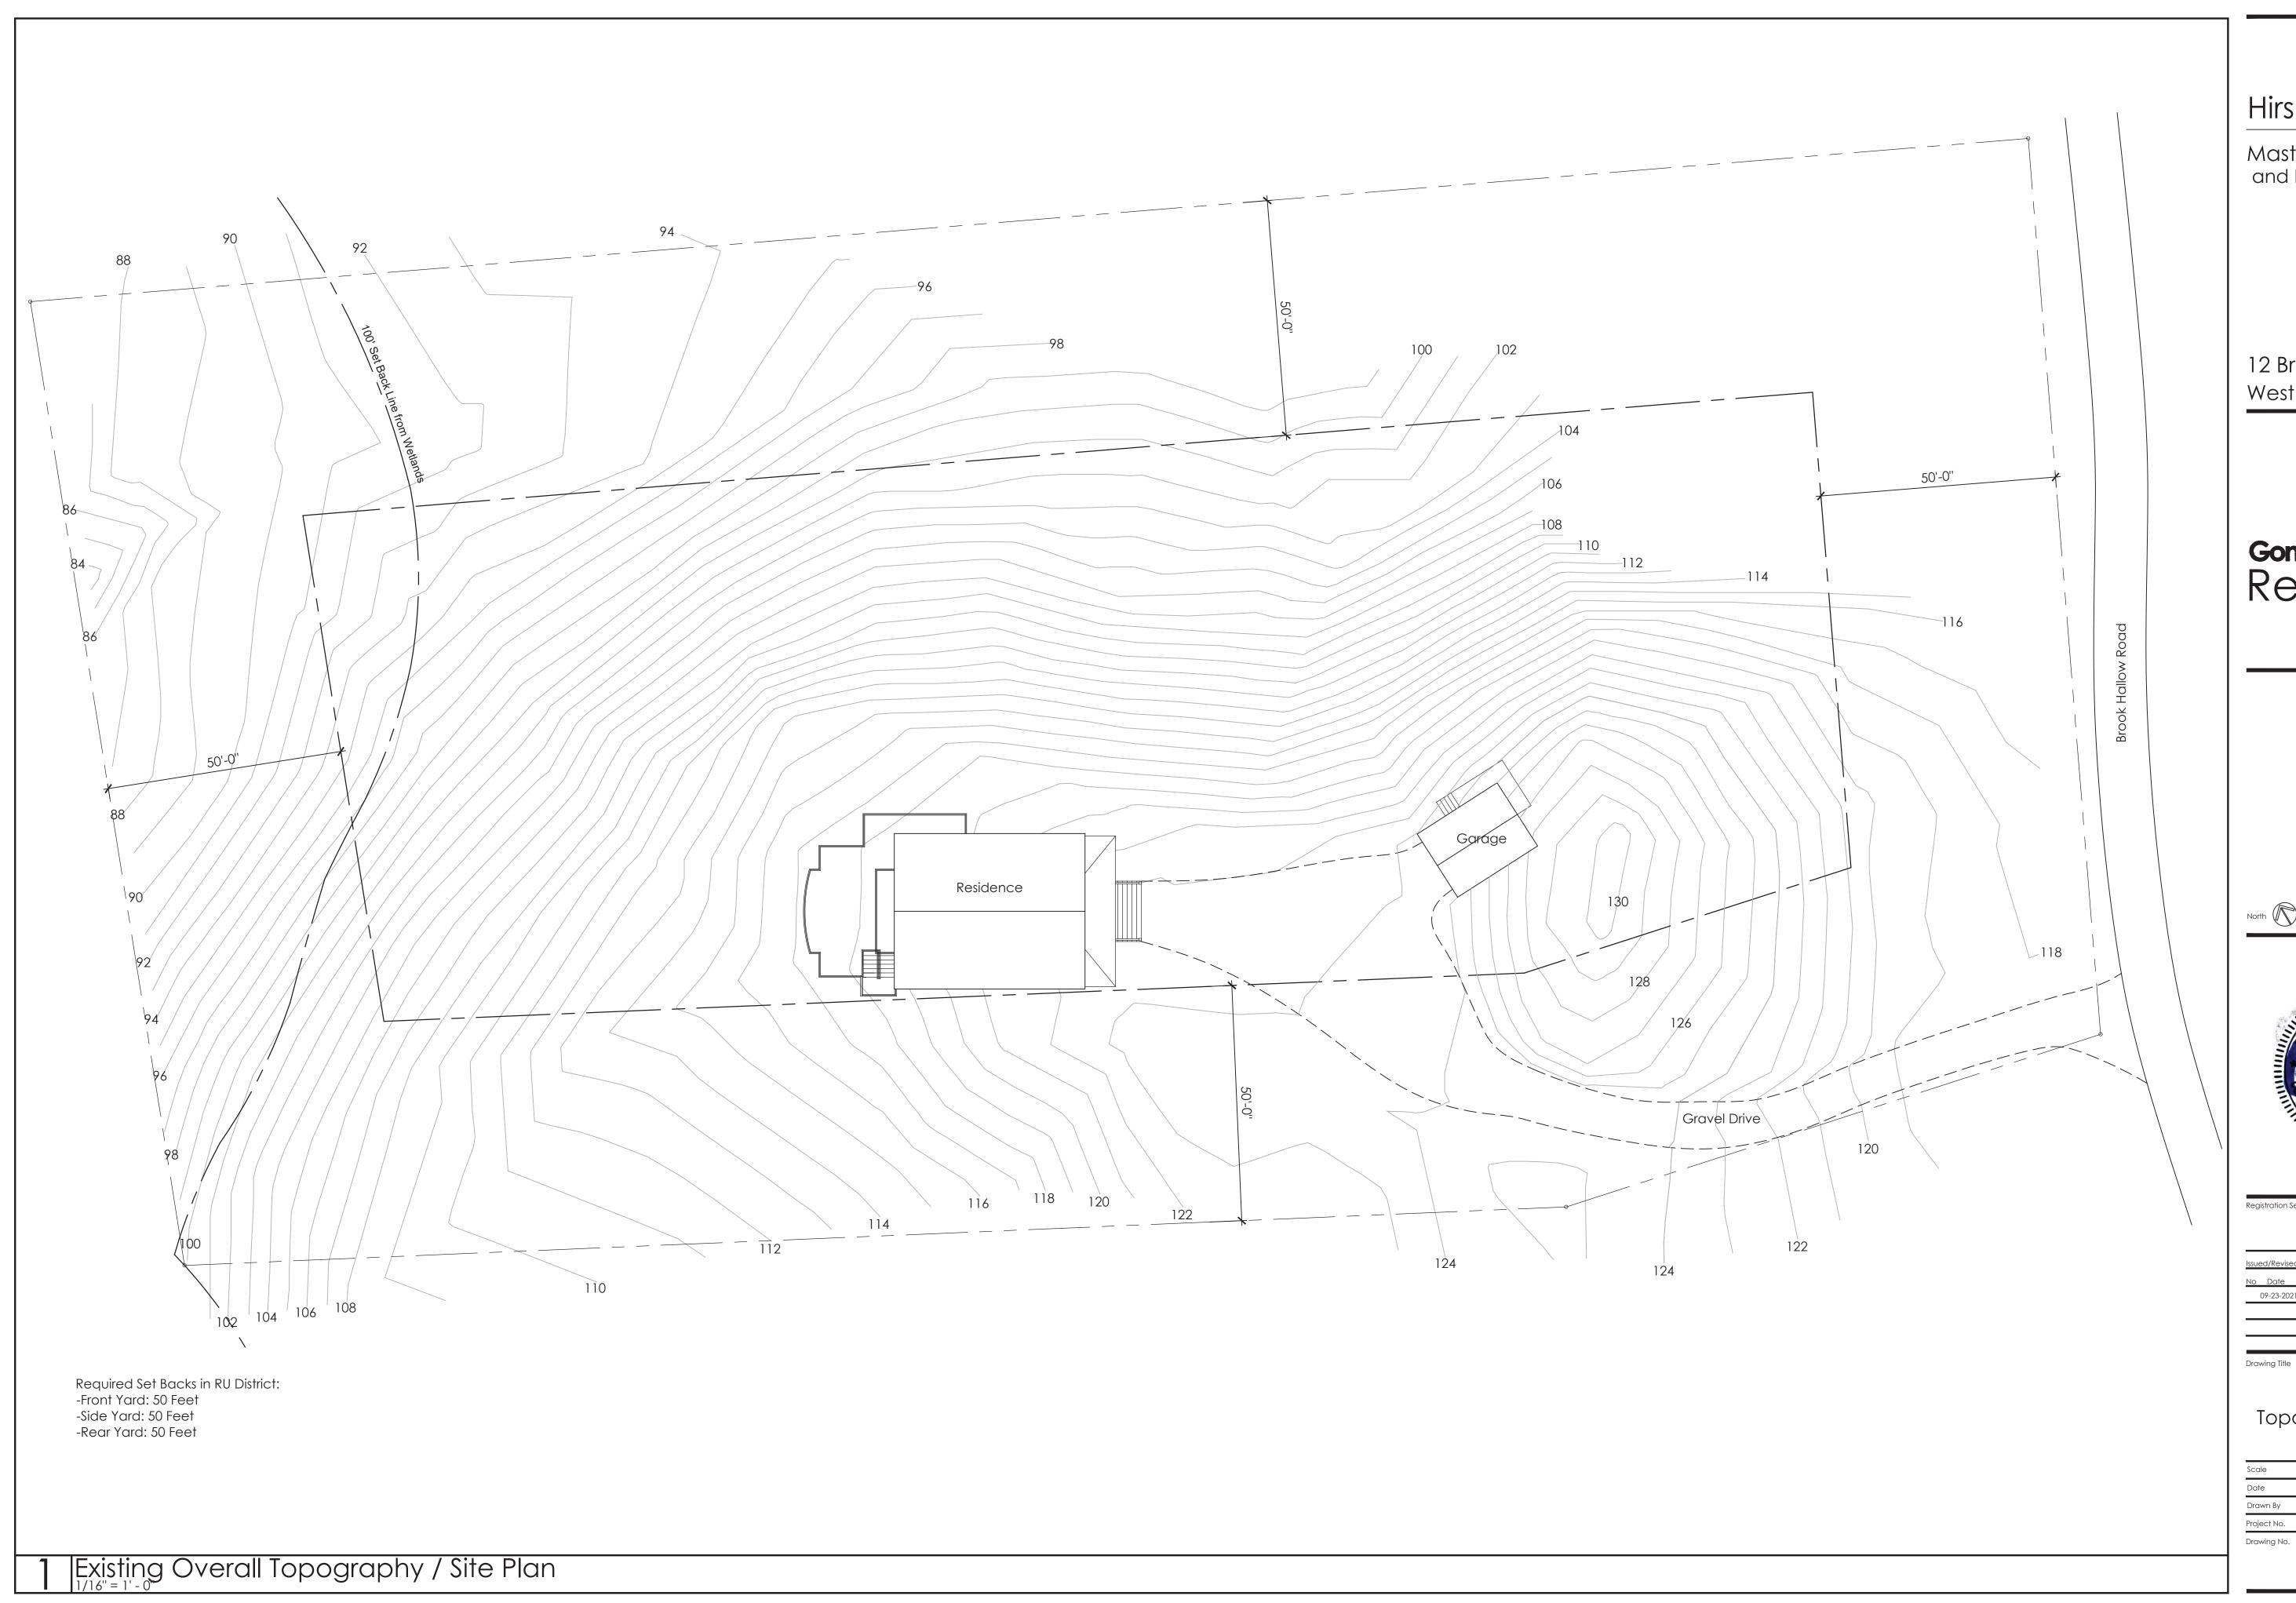

Master Bedroom Suite and Basement Addition

12 Brook Hollow Road West Tisbury, MA 02575




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Address 14 NE First Avenue STE 500 Miami FL 33132 T+1 (305) 455 4216

Esisting Overall Topography / Site Plan



Master Bedroom Suite and Basement Addition

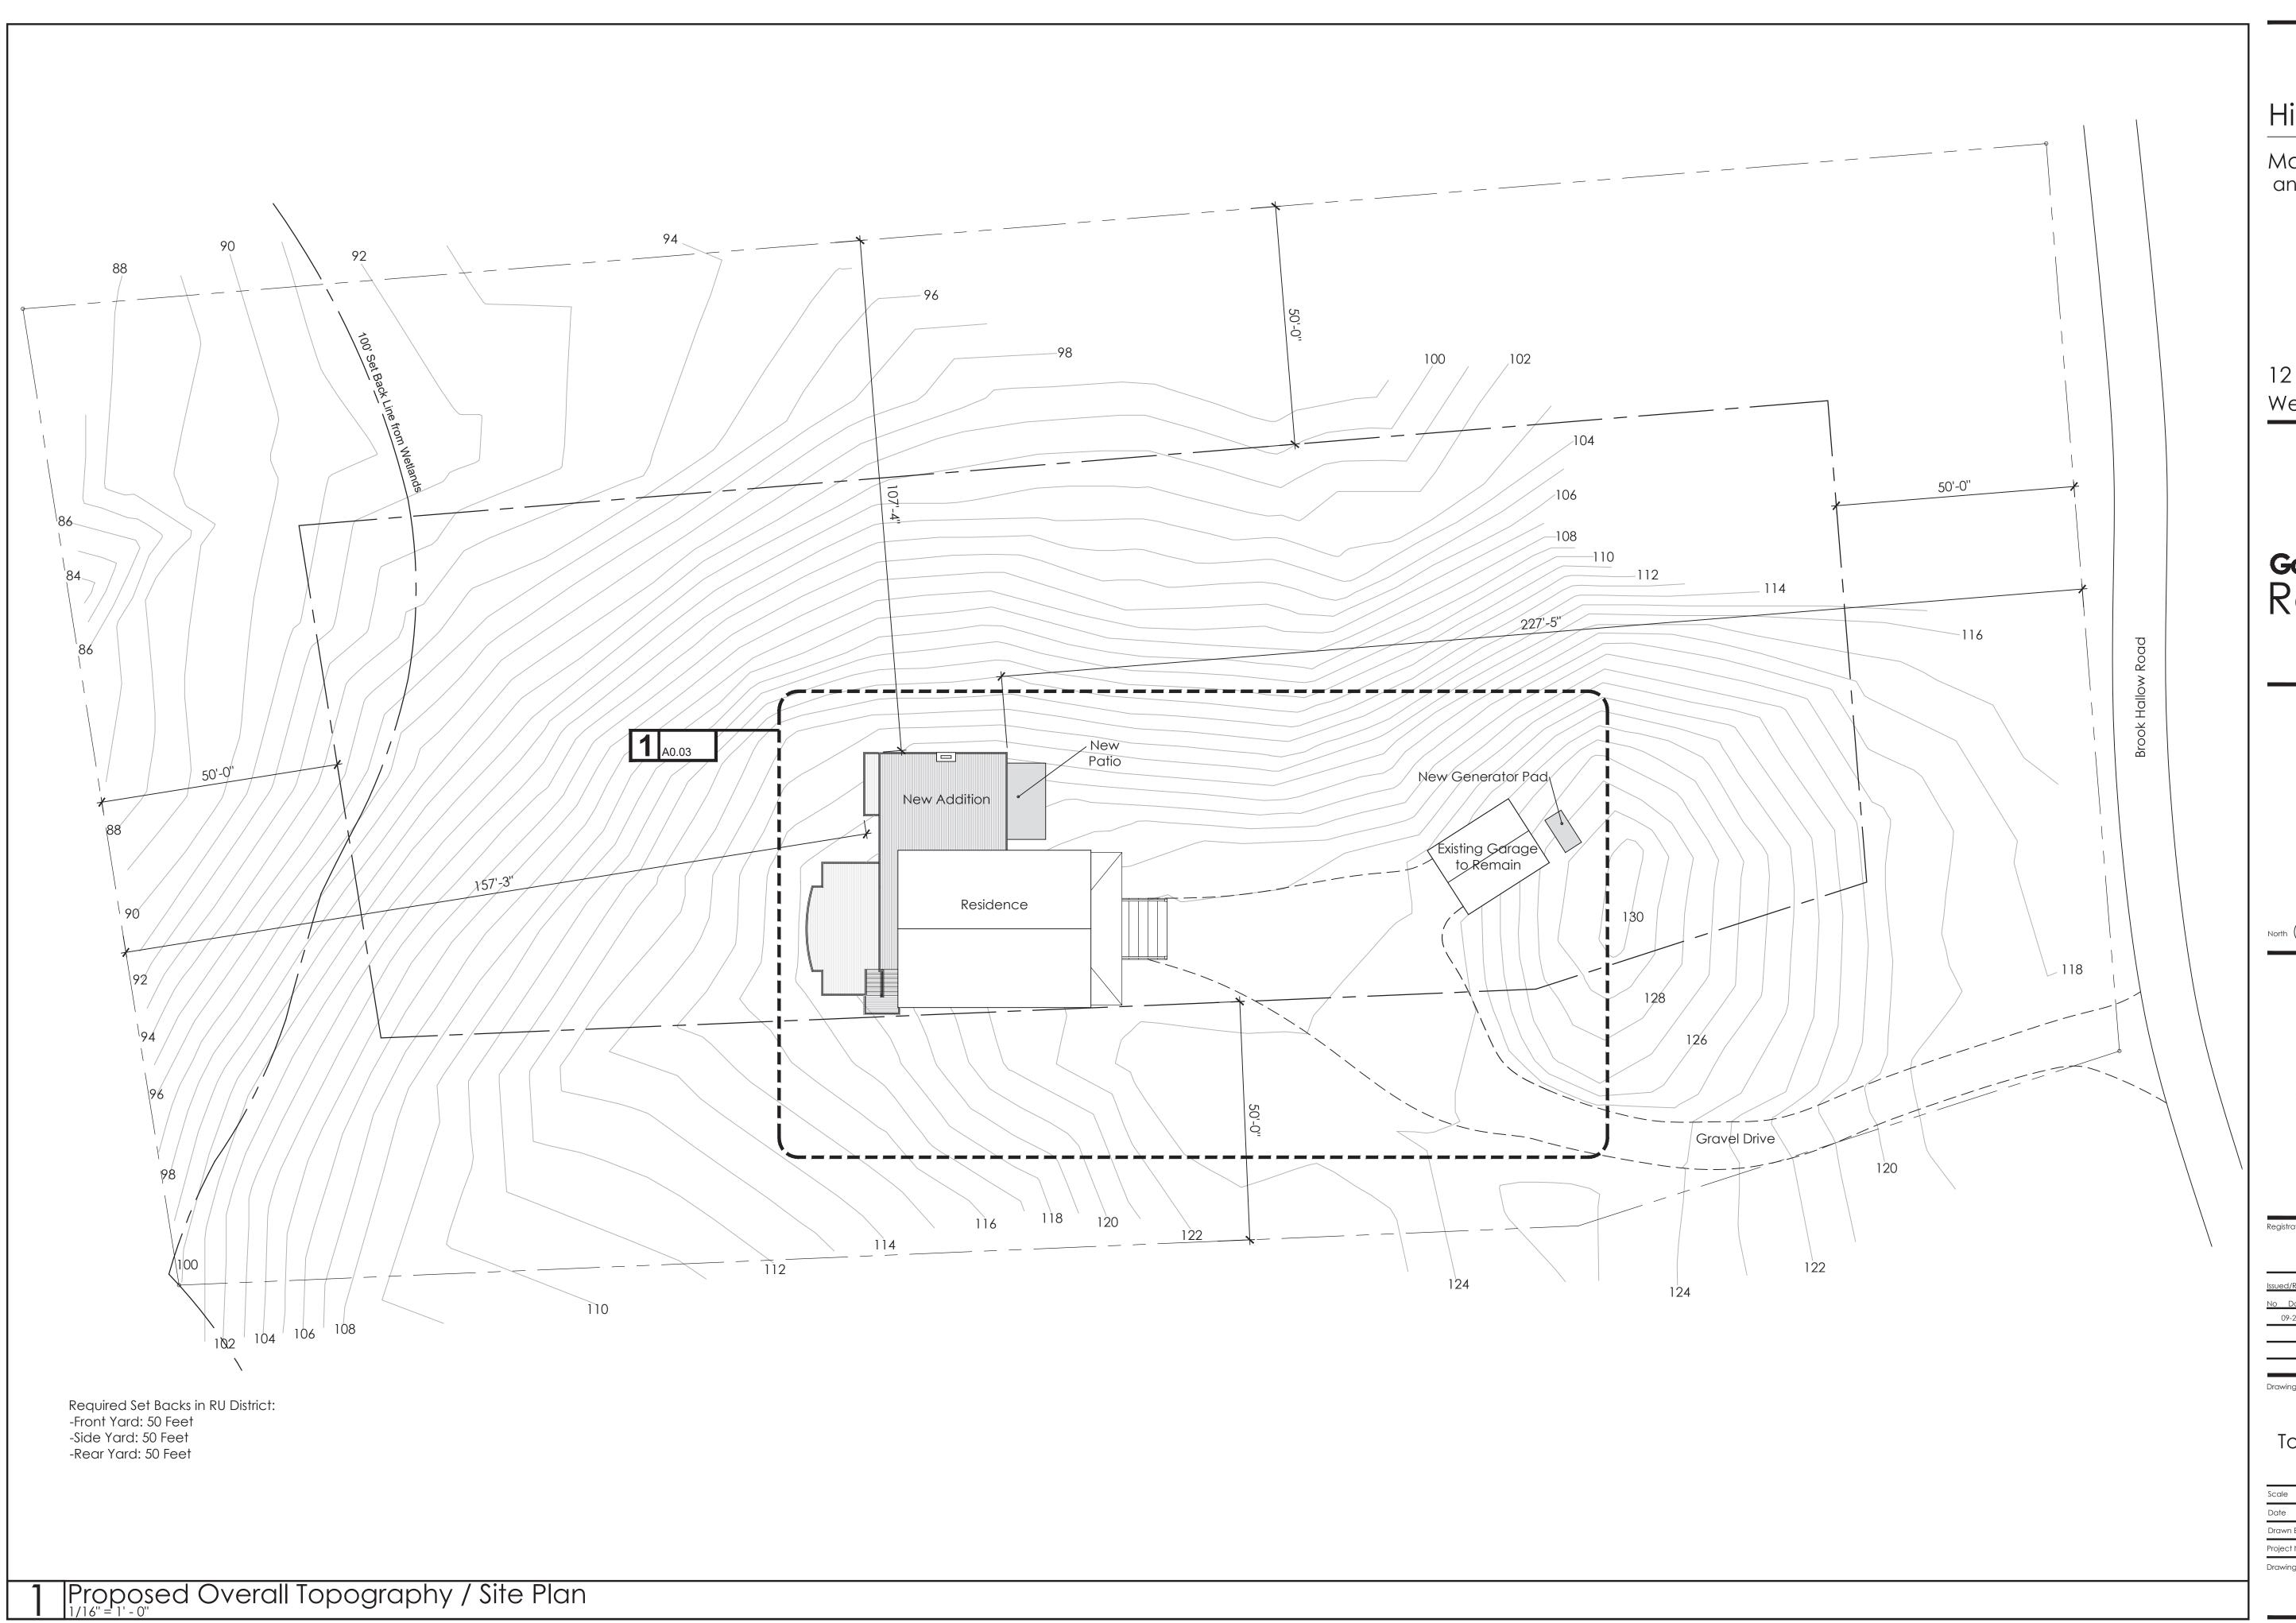12 Brook Hollow Road West Tisbury, MA 02575



# González Architects Residential




Address 14 NE First Avenue STE 500 Miami FL 33132 T +1 (305) 455 4216

Proposed Overall Topography / Site Plan

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Dra	wing No.			

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Master Bedroom Suite and Basement Addition

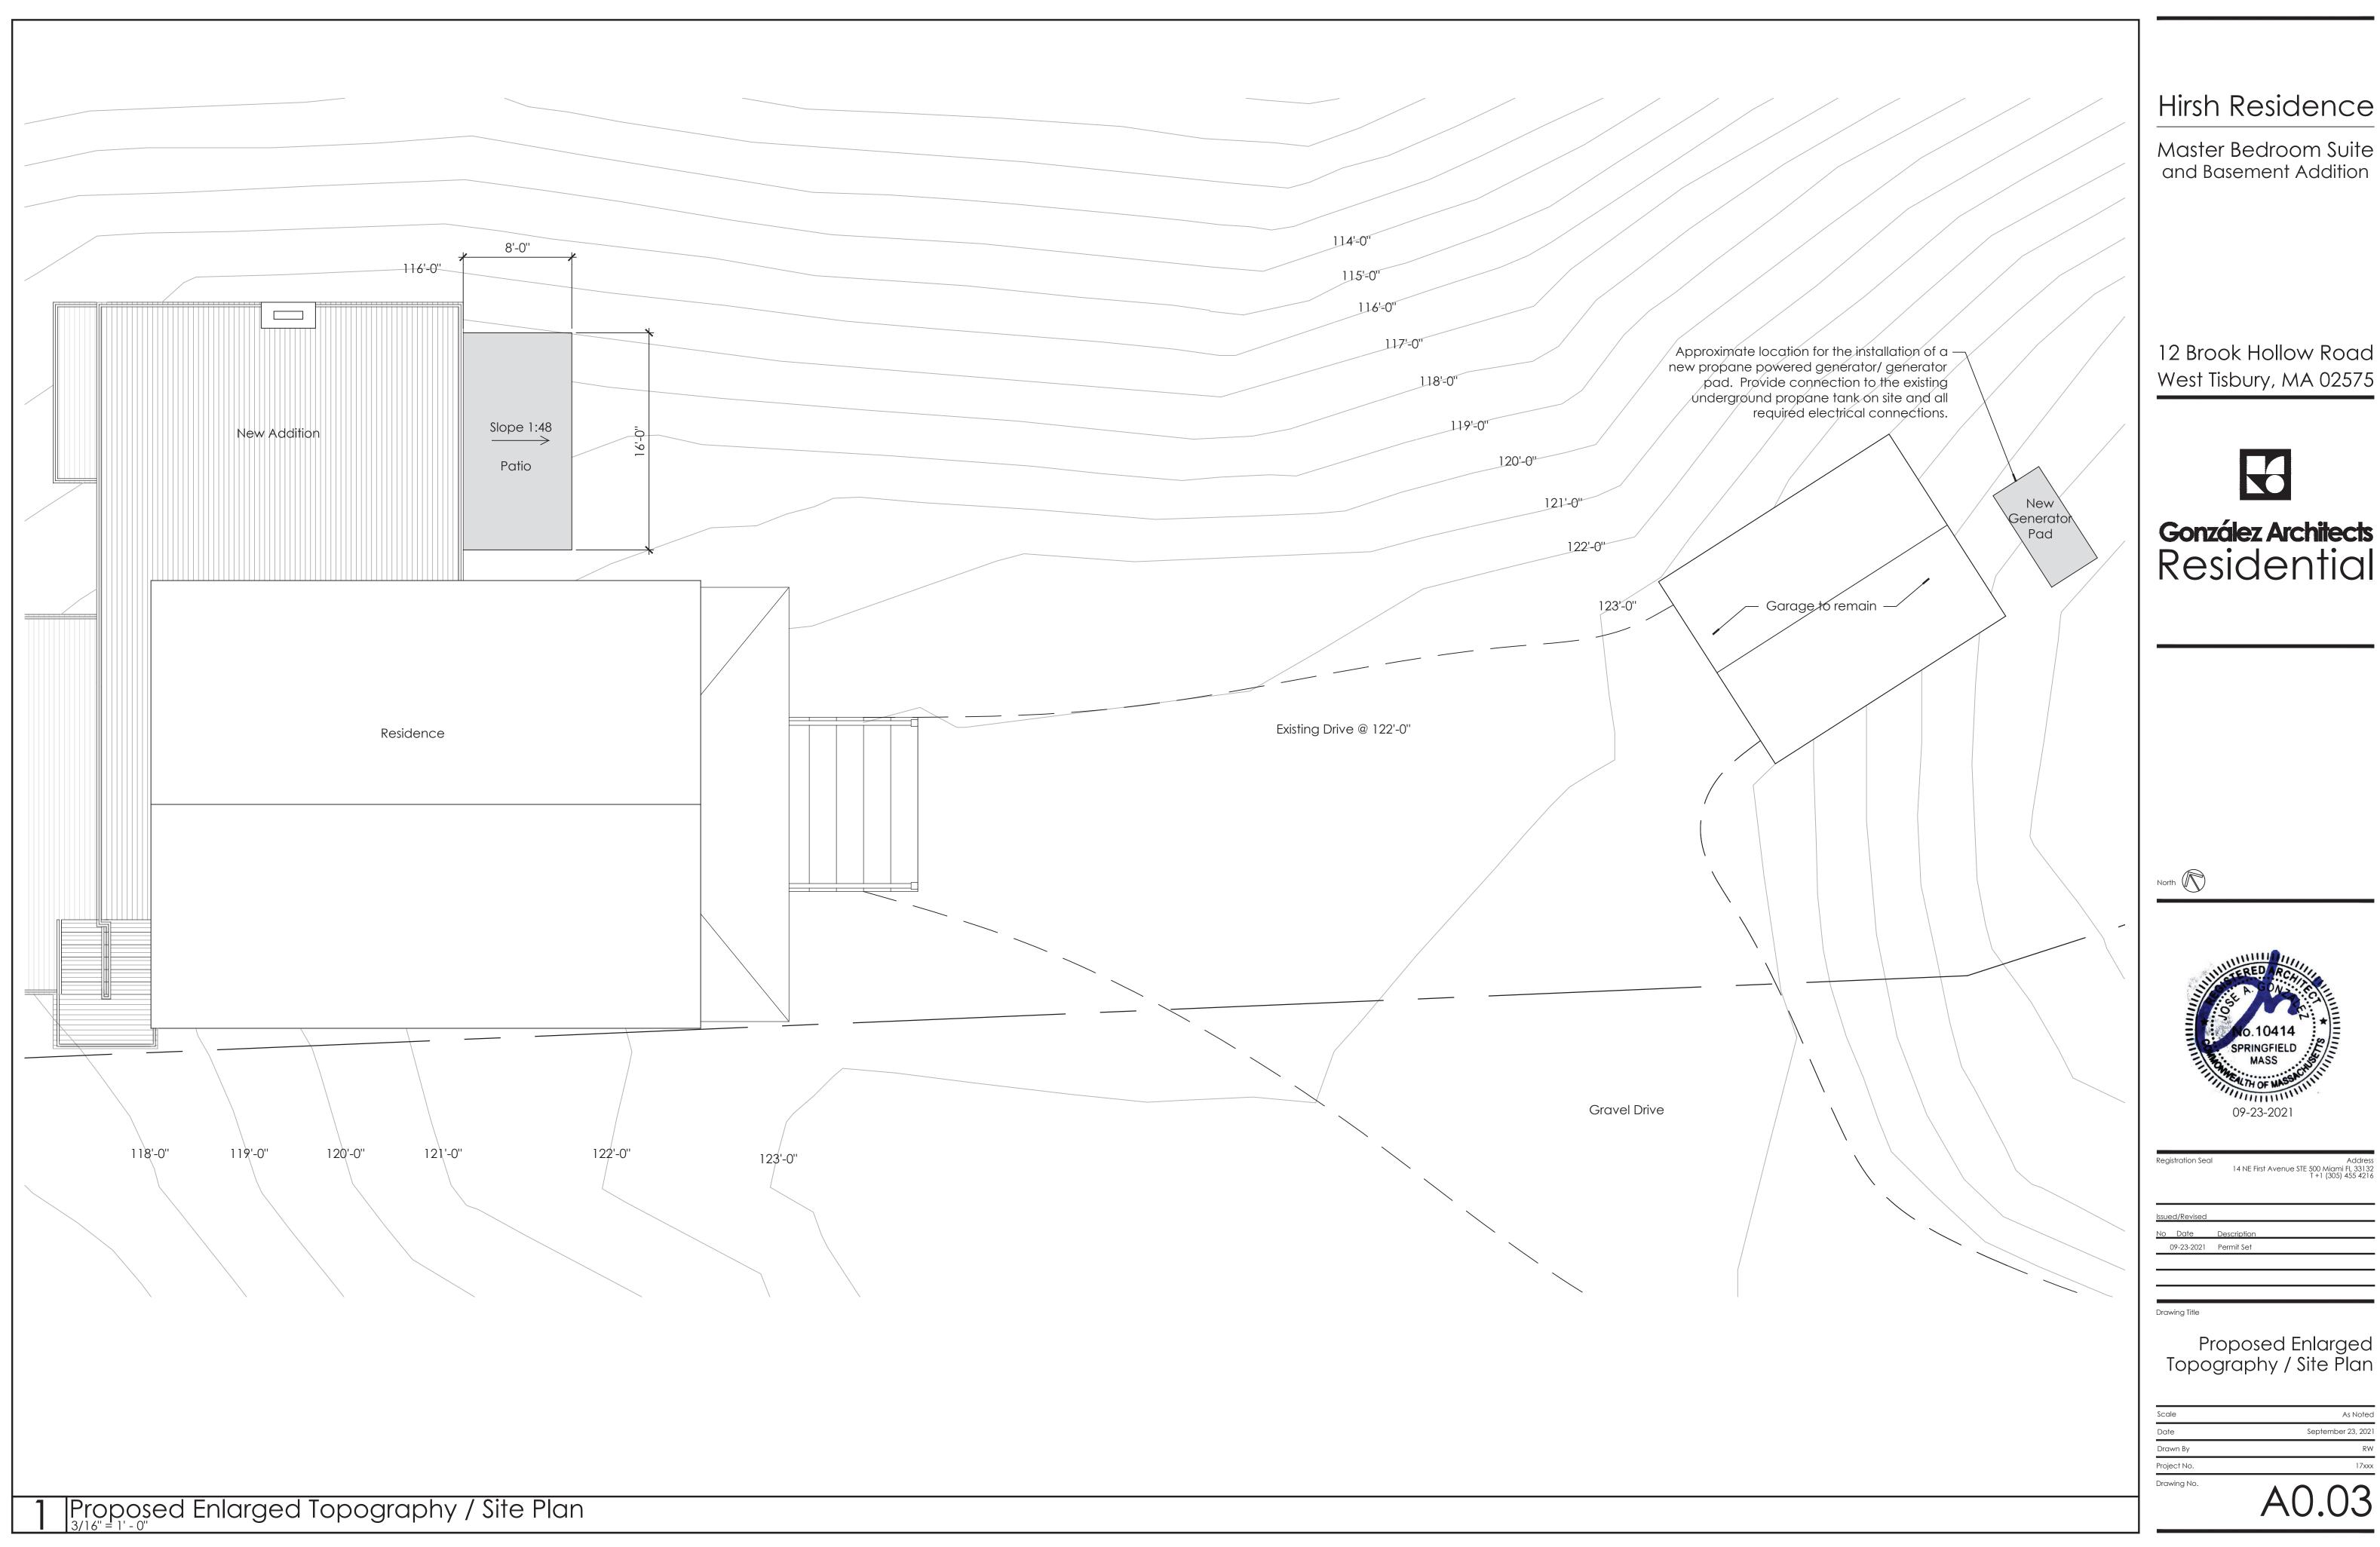
12 Brook Hollow Road West Tisbury, MA 02575



González Architects Residential



Proposed Enlarged Topography / Site Plan

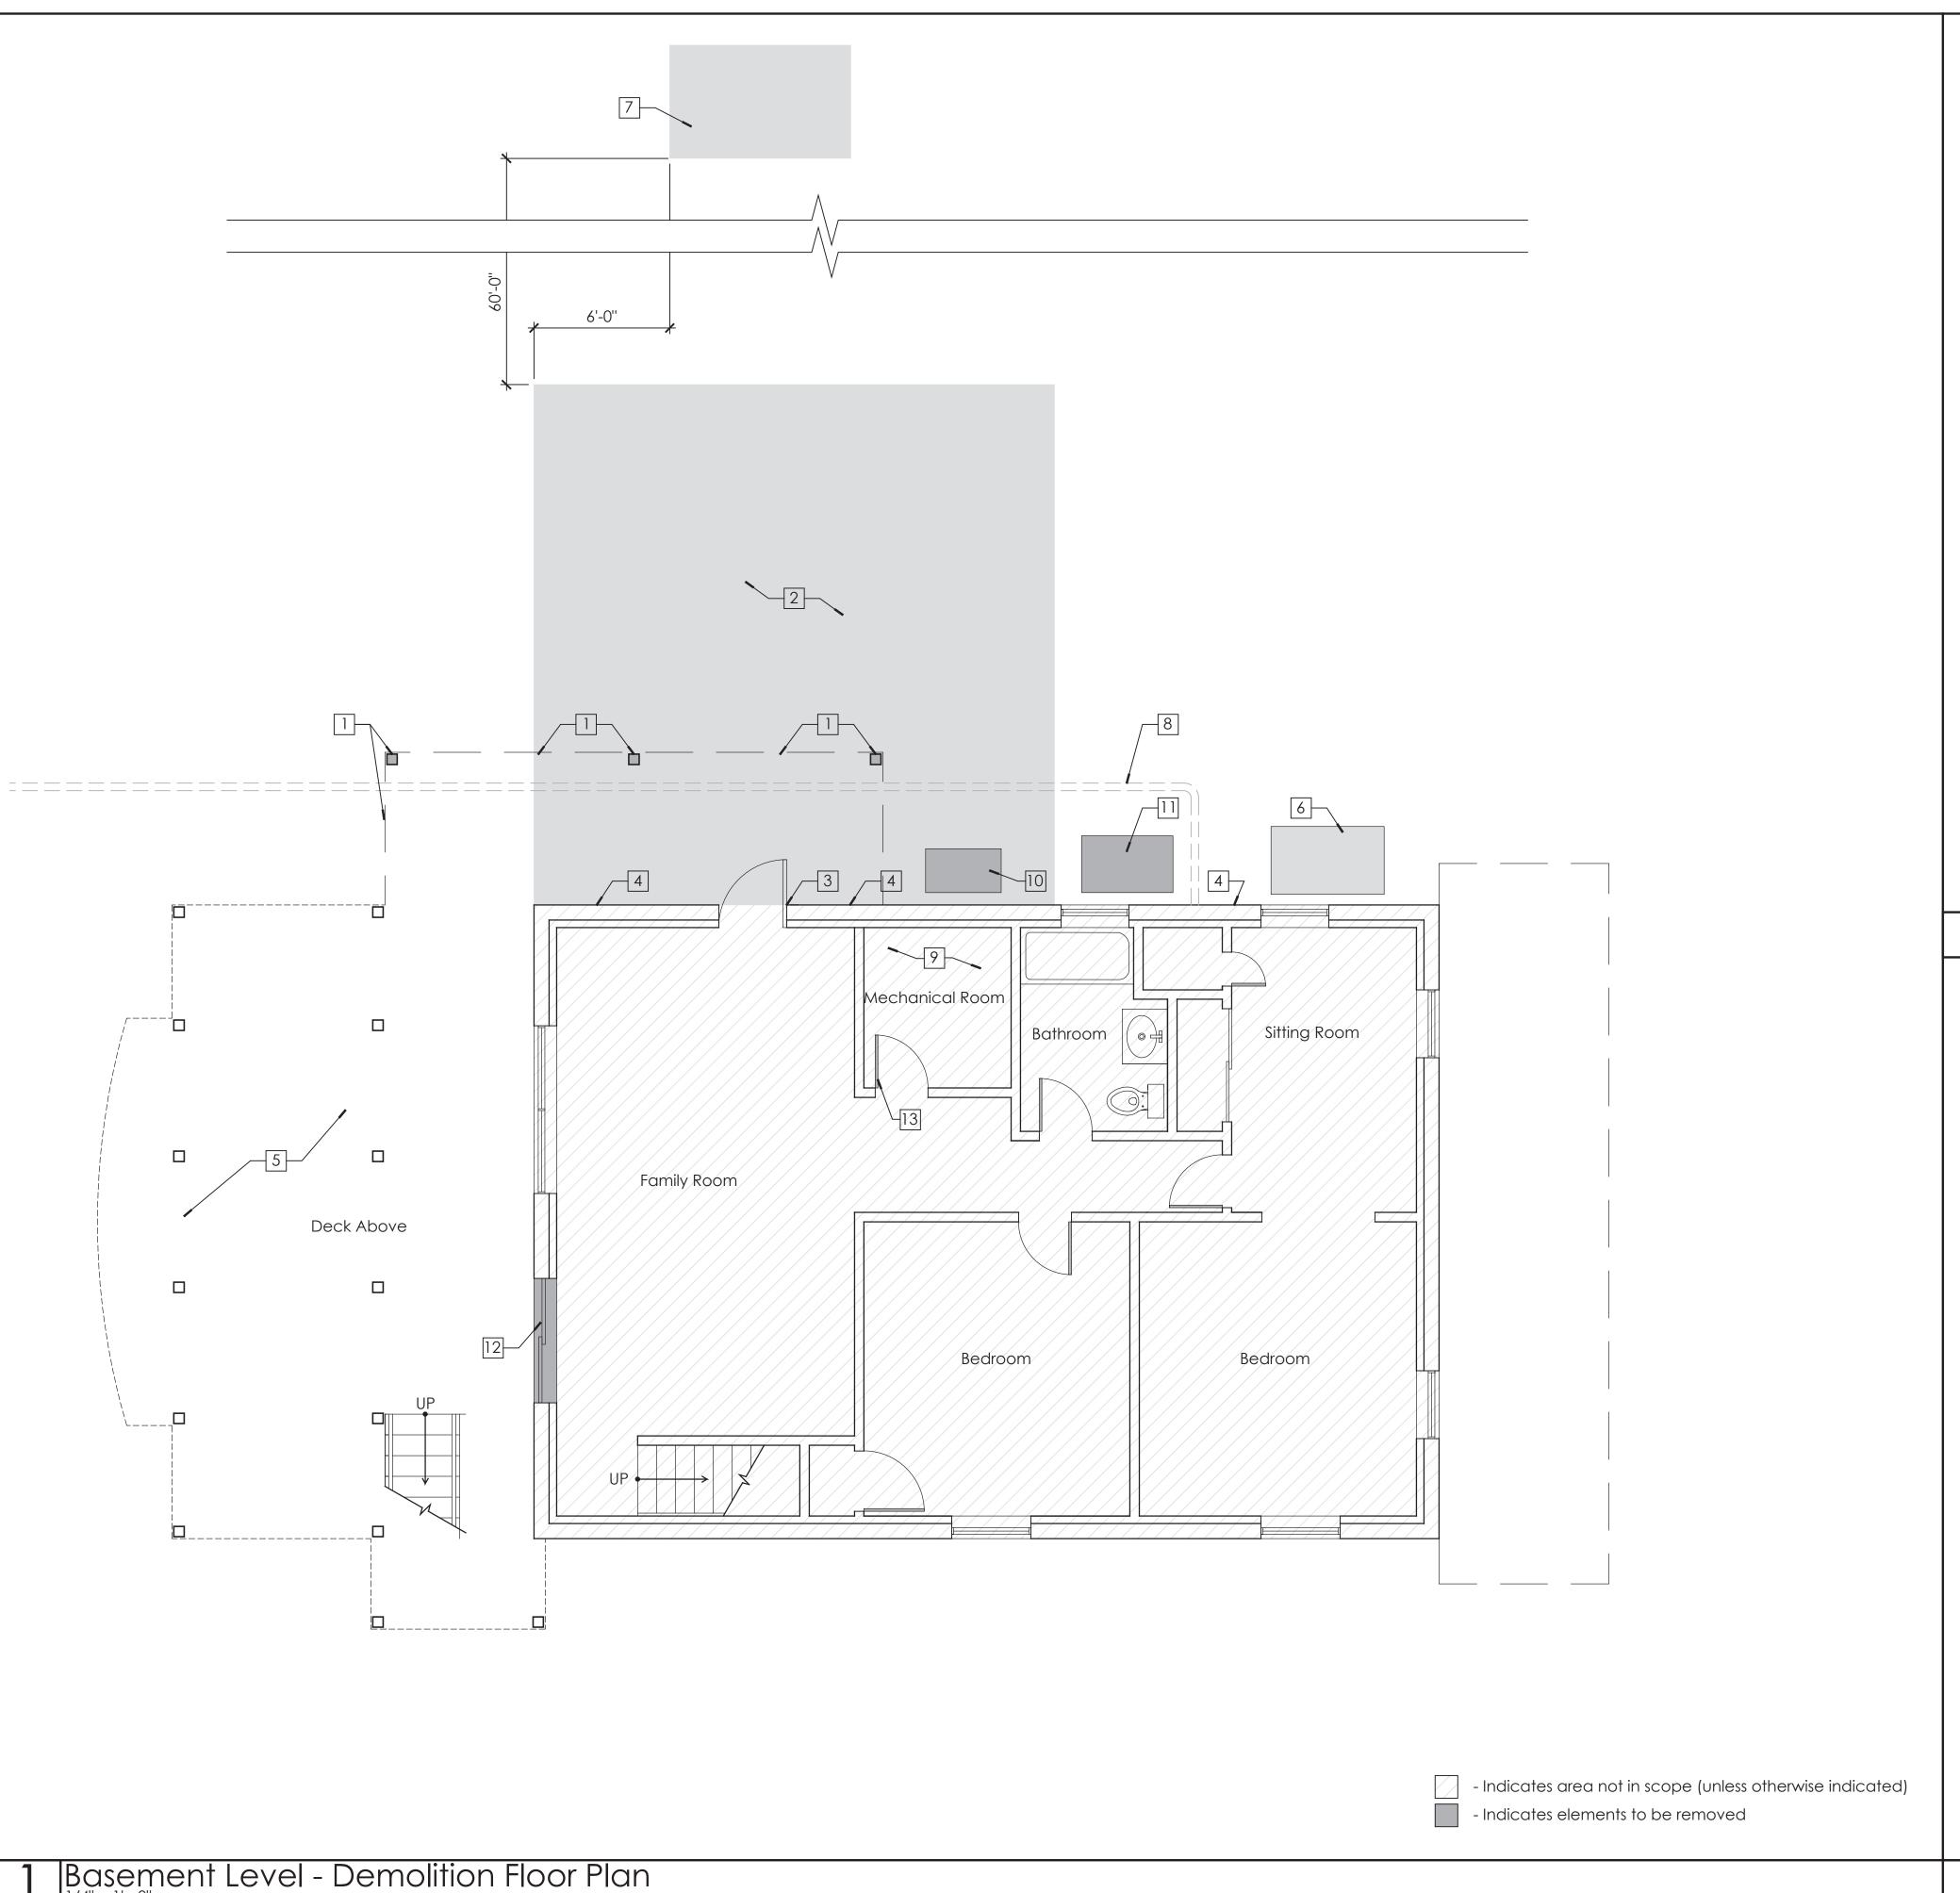

-Required demolition and repair of areas that are necessary to provide the finished work, but not specifically or implicitly indicated in the plans, are the responsibility of the Contractor.

-GC to coordinate all work with home owner to minimize disturbances.

-GC to familiarize him/herself with field conditions prior to commencement of work and notify Architect of any discrepancies or unforeseen conditions prior to commencement

-All dimensions throughout to be verified in field. Shop drawings and samples to be provided before fabrication of all millwork pieces.

-All finishes, flooring, doors, windows, trim, wall paneling, and moldings that are existing to remain shall be protected during demolition and construction. Repair as required.

-Existing electrical outlets, switches, phone, and data to remain throughout, unless otherwise indicated. Protect during demolition and construction. When electrical devices are installed in partitions or ceilings to be removed, the electrical contractor shall disconnect them up to the next outlet to remain or back to the panel board. If existing to remain outlets are fed through demolished partitions or ceilings, the circuit shall be rearranged to maintain circuit continuity. Wire shall be removed back to the source from inaccessible raceways not re-used. Install blank plates on flush outlets not re-used. Plate color shall match adjacent surface near as possible in finished areas. Final finish to be consulted with the Architect.

-All existing structural elements to remain and be protected during demolition and construction.

-Any discrepancy between Architectural drawings and Consultant drawings (i.e. Interiors etc.) is to be immediately brought to the attention of the Architect in writing prior to the continuation of work.

-Provide blocking at all wall mounted accessories, fixtures, etc.

-Where existing wall or floor mounted elements are removed, patch disturbed surfaces to match existing adjacent and prepare to receive new finishes as scheduled.

-All new floor finishes to be installed under cabinetry and millwork, typical.

-All existing conditions in these plans are based on As-Built Floor Plans by MacNelly-Cohen Architects. Existing conditions and dimensions should be verified by contractor for accuracy and any discrepancies shall be reported to the Architect in writing prior to commencement of work.

#### Hirsh Residence

Master Bedroom Suite and Basement Addition

12 Brook Hollow Road West Tisbury, MA 02575



González Architects Residential

#### General Notes

#### **Demolition Notes:**

- Portion of deck above and deck columns to be removed where the existing deck is in conflict with the extents of the new addition. Save and protect mahagany deck boards for use to repair on remaining deck.
- Site to be graded and prepared for new addition foundation as indicated. See proposed plans and details.
- Existing exterior door opening to Family Room to remain and be protected throughout demolition and construction.
- All existing structural foundation walls to remain and be protected throughout demolition and construction.
- Existing deck above and deck columns to remain and be protected during demolition and construction unless otherwise indicated.
- Existing pool equipment to be relocated. Coordinate equipment relocation with pool equipment consultant.
- Prepare for new pool equipment pad. Coordinate with pool equipment consultant for required size and location of pad.
- Existing sewer line to septic to be relocated as required for the installation of new foundation. Contractor to verify existing location and depth of sewer line
- 9 Existing oil boiler to be removed.

Demolition Notes

- 10 Remove existing oil tank.
- Existing HVAC equipment to be removed. Equipment pad to remain and be reused for new central air unit.
- Existing Basement sliding doors to be removed and replaced with new sliding doors. New doors shall match the size of the existing.
- 13 Change Mechanical room door swing to swing out into the Hall.





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No Date Description

09-23-2021 Permit Set

Drawing Title

Basement Level Demolition Floor Plan

Scale As Noted


Date September 23, 2021

Drawn By RW

Project No. 17xxx

Drawing No.

D1.0

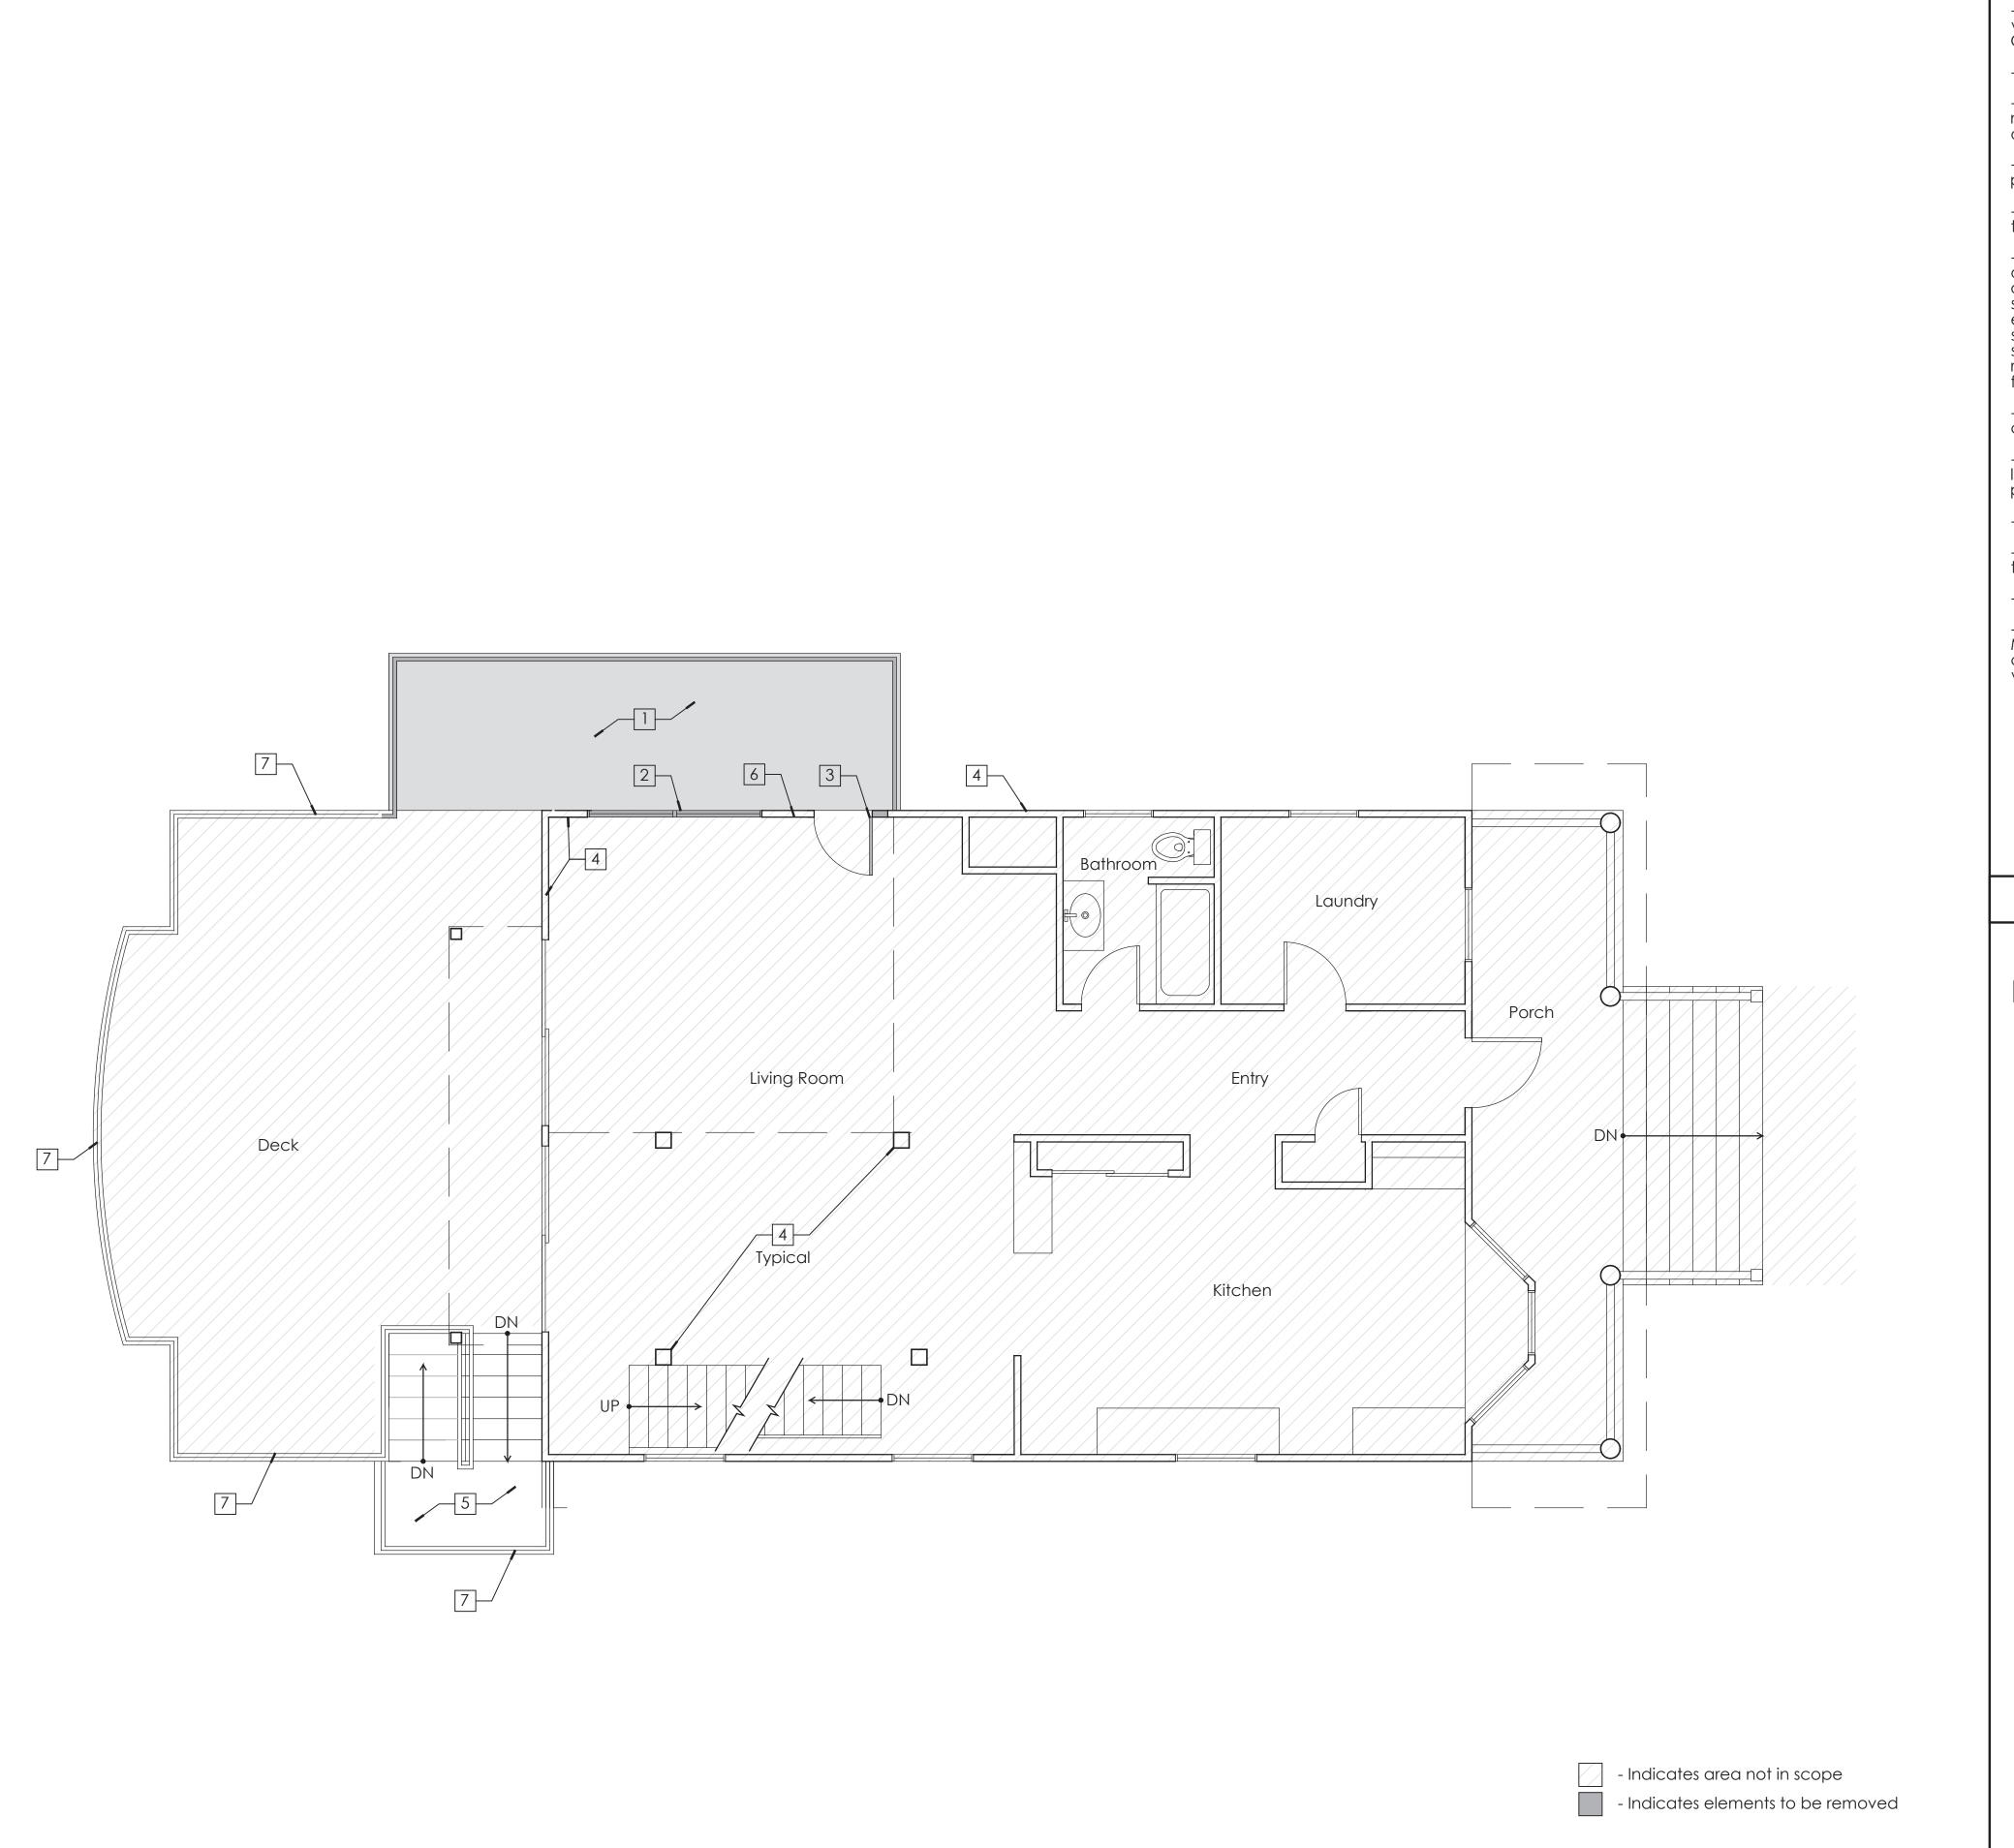

First Level - Demolition Floor Plan

#### General Notes:

-Required demolition and repair of areas that are necessary to provide the finished work, but not specifically or implicitly indicated in the plans, are the responsibility of the Contractor.

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-GC to familiarize him/herself with field conditions prior to commencement of work and notify Architect of any discrepancies or unforeseen conditions prior to commencement of work

-All dimensions throughout to be verified in field. Shop drawings and samples to be provided before fabrication of all millwork pieces.

-All finishes, flooring, doors, windows, trim, wall paneling, and moldings that are existing to remain shall be protected during demolition and construction. Repair as required.

-Existing electrical outlets, switches, phone, and data to remain throughout, unless otherwise indicated. Protect during demolition and construction. When electrical devices are installed in partitions or ceilings to be removed, the electrical contractor shall disconnect them up to the next outlet to remain or back to the panel board. If existing to remain outlets are fed through demolished partitions or ceilings, the circuit shall be rearranged to maintain circuit continuity. Wire shall be removed back to the source from inaccessible raceways not re-used. Install blank plates on flush outlets not re-used. Plate color shall match adjacent surface near as possible in finished areas. Final finish to be consulted with the Architect.

-All existing structural elements to remain and be protected during demolition and construction.

-Any discrepancy between Architectural drawings and Consultant drawings (i.e. Interiors etc.) is to be immediately brought to the attention of the Architect in writing prior to the continuation of work.

-Provide blocking at all wall mounted accessories, fixtures, etc.

-Where existing wall or floor mounted elements are removed, patch disturbed surfaces to match existing adjacent and prepare to receive new finishes as scheduled.

-All new floor finishes to be installed under cabinetry and millwork, typical.

-All existing conditions in these plans are based on As-Built Floor Plans by MacNelly-Cohen Architects. Existing conditions and dimensions should be verified by contractor for accuracy and any discrepancies shall be reported to the Architect in writing prior to commencement of work.

#### Hirsh Residence

Master Bedroom Suite and Basement Addition

12 Brook Hollow Road West Tisbury, MA 02575



González Architects Residential

#### General Notes

#### **Demolition Notes:**

- Portion of deck to be removed where the existing deck is in conflict with the extents of the new addition. Save and protect mahogany deck boards for use to repair on temaining deck
- 2 Existing window to be removed, prepare wall for infill. Existing through wall A/C unit to be removed, save & protect A/C unit.
- Existing exterior door to be replaced with new reversed interior door at end of project and portion of wall to be remain with additional weather tight during renovation.
- All existing structural walls and columns to remain and be protected throughout demolition and construction unless otherwise indicated.
- Prepare for the installation of new deck stairs extending the existing stairs up to the new second level roof deck. See proposed plan.
- 6 Remove and retain exterior light fixture.
- All deck railings to be replaced with horizontal metal wire railing system. Gaps between wires shall be less then 4" typical.





Issued/Revised

No Date Description

09-23-2021 Permit Set

Drawing Title

Drawing No.

First Level Demolition Floor Plan

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Project No.	17x>

D1.02

Demolition Notes

# Sitting Area Sitting Area Sedroom Bedroom Be

#### General Notes:

-Required demolition and repair of areas that are necessary to provide the finished work, but not specifically or implicitly indicated in the plans, are the responsibility of the Contractor.

-GC to coordinate all work with home owner to minimize disturbances.

-GC to familiarize him/herself with field conditions prior to commencement of work and notify Architect of any discrepancies or unforeseen conditions prior to commencement of work

-All dimensions throughout to be verified in field. Shop drawings and samples to be provided before fabrication of all millwork pieces.

-All finishes, flooring, doors, windows, trim, wall paneling, and moldings that are existing to remain shall be protected during demolition and construction. Repair as required.

-Existing electrical outlets, switches, phone, and data to remain throughout, unless otherwise indicated. Protect during demolition and construction. When electrical devices are installed in partitions or ceilings to be removed, the electrical contractor shall disconnect them up to the next outlet to remain or back to the panel board. If existing to remain outlets are fed through demolished partitions or ceilings, the circuit shall be rearranged to maintain circuit continuity. Wire shall be removed back to the source from inaccessible raceways not re-used. Install blank plates on flush outlets not re-used. Plate color shall match adjacent surface near as possible in finished areas. Final finish to be consulted with the Architect.

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-Any discrepancy between Architectural drawings and Consultant drawings (i.e. Interiors etc.) is to be immediately brought to the attention of the Architect in writing prior to the continuation of work.

-Provide blocking at all wall mounted accessories, fixtures, etc.

-Where existing wall or floor mounted elements are removed, patch disturbed surfaces to match existing adjacent and prepare to receive new finishes as scheduled.

-All new floor finishes to be installed under cabinetry and millwork, typical.

-All existing conditions in these plans are based on As-Built Floor Plans by MacNelly-Cohen Architects. Existing conditions and dimensions should be verified by contractor for accuracy and any discrepancies shall be reported to the Architect in writing prior to commencement of work.

#### Hirsh Residence

Master Bedroom Suite and Basement Addition

12 Brook Hollow Road West Tisbury, MA 02575



González Architects Residential

#### General Notes

#### **Demolition Notes:**

- Portion of deck railing to be removed where the existing deck will connect to the new stairs and new roof deck. See proposed plans. Save deck railing for reuse
- 2 Existing deck to remain and be protected during demolition and construction.
- All existing structural walls and columns to remain and be protected throughout demolition and construction unless otherwise indicated.
- Prepare for the installation of new deck stairs connecting the second level deck to the first level deck. See proposed plan
- All deck railings to be replaced with horizontal metal wire railing system. Gaps between wires shall be less then 4" typical.
- Demolish openings in upper living room wall for new transom windows.





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No Date Description
09-23-2021 Permit Set

Drawing Title

Drawing No.

Second Level Demolition Floor Plan

Scale As Noted


Date September 23, 2021

Drawn By RW

Project No. 17xxx

D1.03

Indicates area not in scopeIndicates elements to be removed

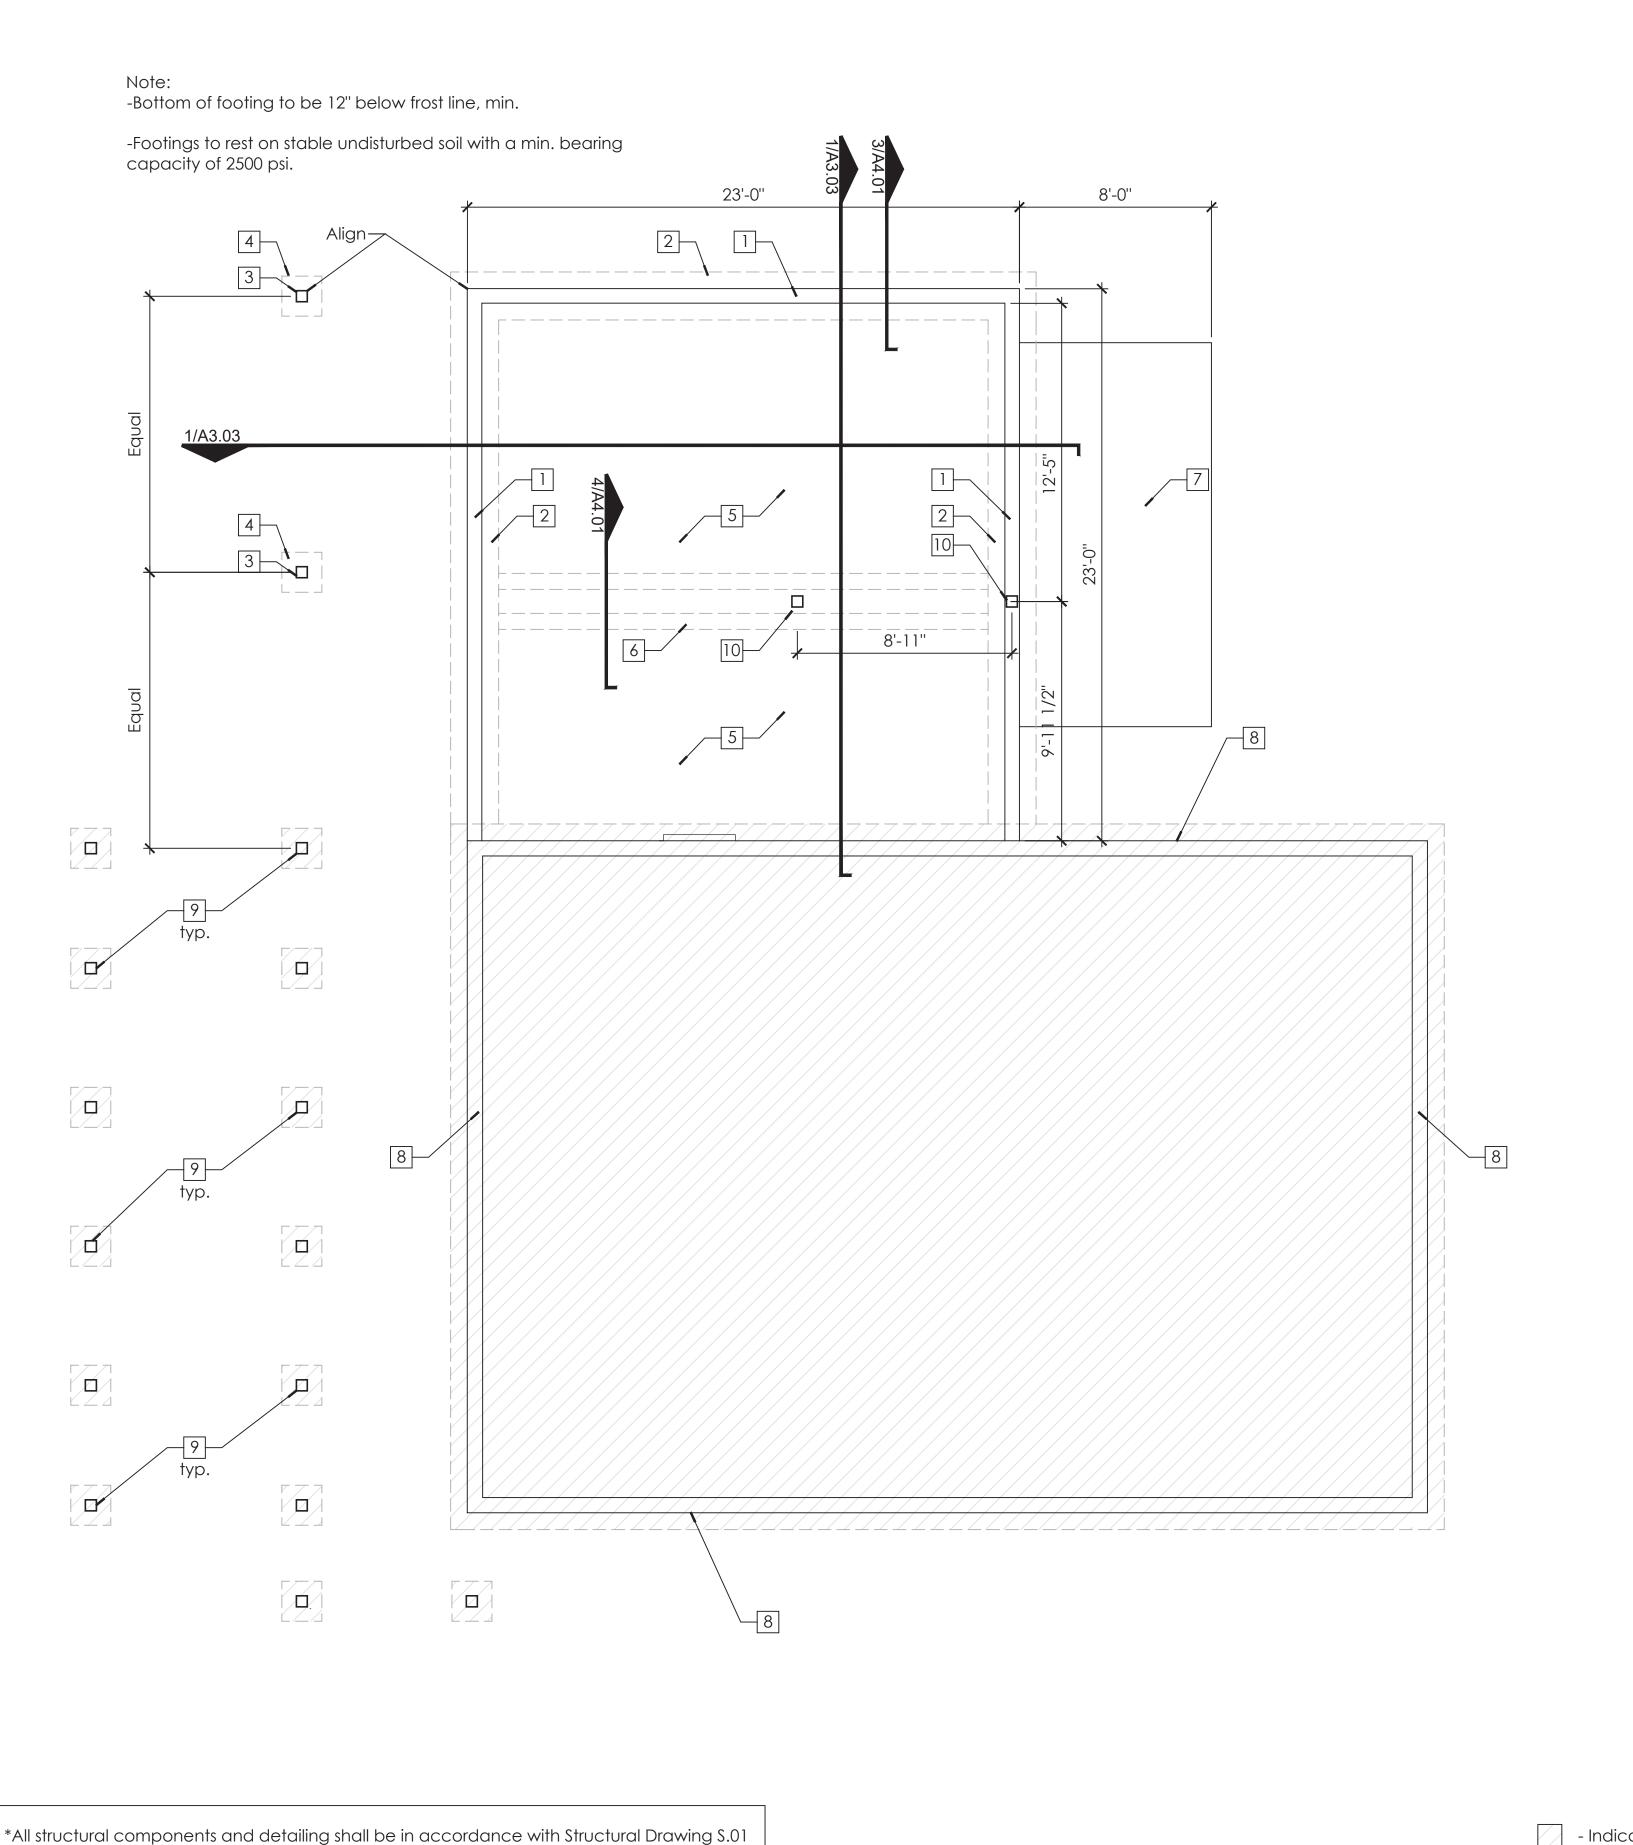

Master Bedroom Suite and Basement Addition

12 Brook Hollow Road West Tisbury, MA 02575

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-All finishes, flooring, doors, windows, trim, wall paneling, and moldings that are existing to remain shall be protected during demolition and construction. Repair as required.

-All dimensions throughout to be verified in field. Shop drawings and samples to be provided before fabrication of all millwork pieces.

-GC to familiarize him/herself with field conditions prior to commencement of work and notify Architect of any discrepancies or unforeseen conditions prior to commencement

-Required demolition and repair of areas that are necessary to provide the finished work, but not specifically or implicitly indicated in the plans, are the responsibility of the

-GC to coordinate all work with home owner to minimize disturbances.

-Existing electrical outlets, switches, phone, and data to remain throughout, unless otherwise indicated. Protect during demolition and construction. When electrical devices are installed in partitions or ceilings to be removed, the electrical contractor shall disconnect them up to the next outlet to remain or back to the panel board. If existing to remain outlets are fed through demolished partitions or ceilings, the circuit shall be rearranged to maintain circuit continuity. Wire shall be removed back to the source from inaccessible raceways not re-used. Install blank plates on flush outlets not re-used. Plate color shall match adjacent surface near as possible in finished areas. Final finish to be consulted with the Architect.

-All existing structural elements to remain and be protected during demolition and construction.

-Any discrepancy between Architectural drawings and Consultant drawings (i.e. Interiors etc.) is to be immediately brought to the attention of the Architect in writing prior to the continuation of work.

-Provide blocking at all wall mounted accessories, fixtures, etc.

-Where existing wall or floor mounted elements are removed, patch disturbed surfaces to match existing adjacent and prepare to receive new finishes as scheduled.

-All new floor finishes to be installed under cabinetry and millwork, typical.

-All existing conditions in these plans are based on As-Built Floor Plans by MacNelly-Cohen Architects. Existing conditions and dimensions should be verified by contractor for accuracy and any discrepancies shall be reported to the Architect in writing prior to commencement of work.

#### General Notes

Notes:

General Notes:

- New CMU foundation wall with vertical reinforcement.
- 2 Concrete footing with steel dowels to anchor foundation wall to footing.
- Concrete pier @ deck posts with vertical reinforcement and lateral reinforcement ties. Posts to martch existing deck posts.
- Concrete pier footing with two way reinforcement with a steel dowel to anchor pier to footing.
- 5 4" Concrete slab on grade with welded wire fabric reinforcement on 6 MIL Visqueen vapor barrier and continuous rigid foam insulation.
- Thickened slab with reinforcement @ interior load bearing partition.
- 7 4" Exterior patio concrete slab with welded wire fabric reinforcement with desigate topping stone finish to drain away from the new addition. See details
- 8 Existing foundation wall, footing, and slab to remain and be protected during demolition and construction.
- 9 Existing concrete deck piers and footing to remain and be protected during demolition and construction.
- New columns as scheduled, see Structural Drawings.

North



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No Date Description

09-23-2021 Permit Set

Drawing Title

Foundation Plan


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Date	September 23, 202
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- Indicates area not in scope

Foundation Plan

Notes



-Required demolition and repair of areas that are necessary to provide the finished work, but not specifically or implicitly indicated in the plans, are the responsibility of the

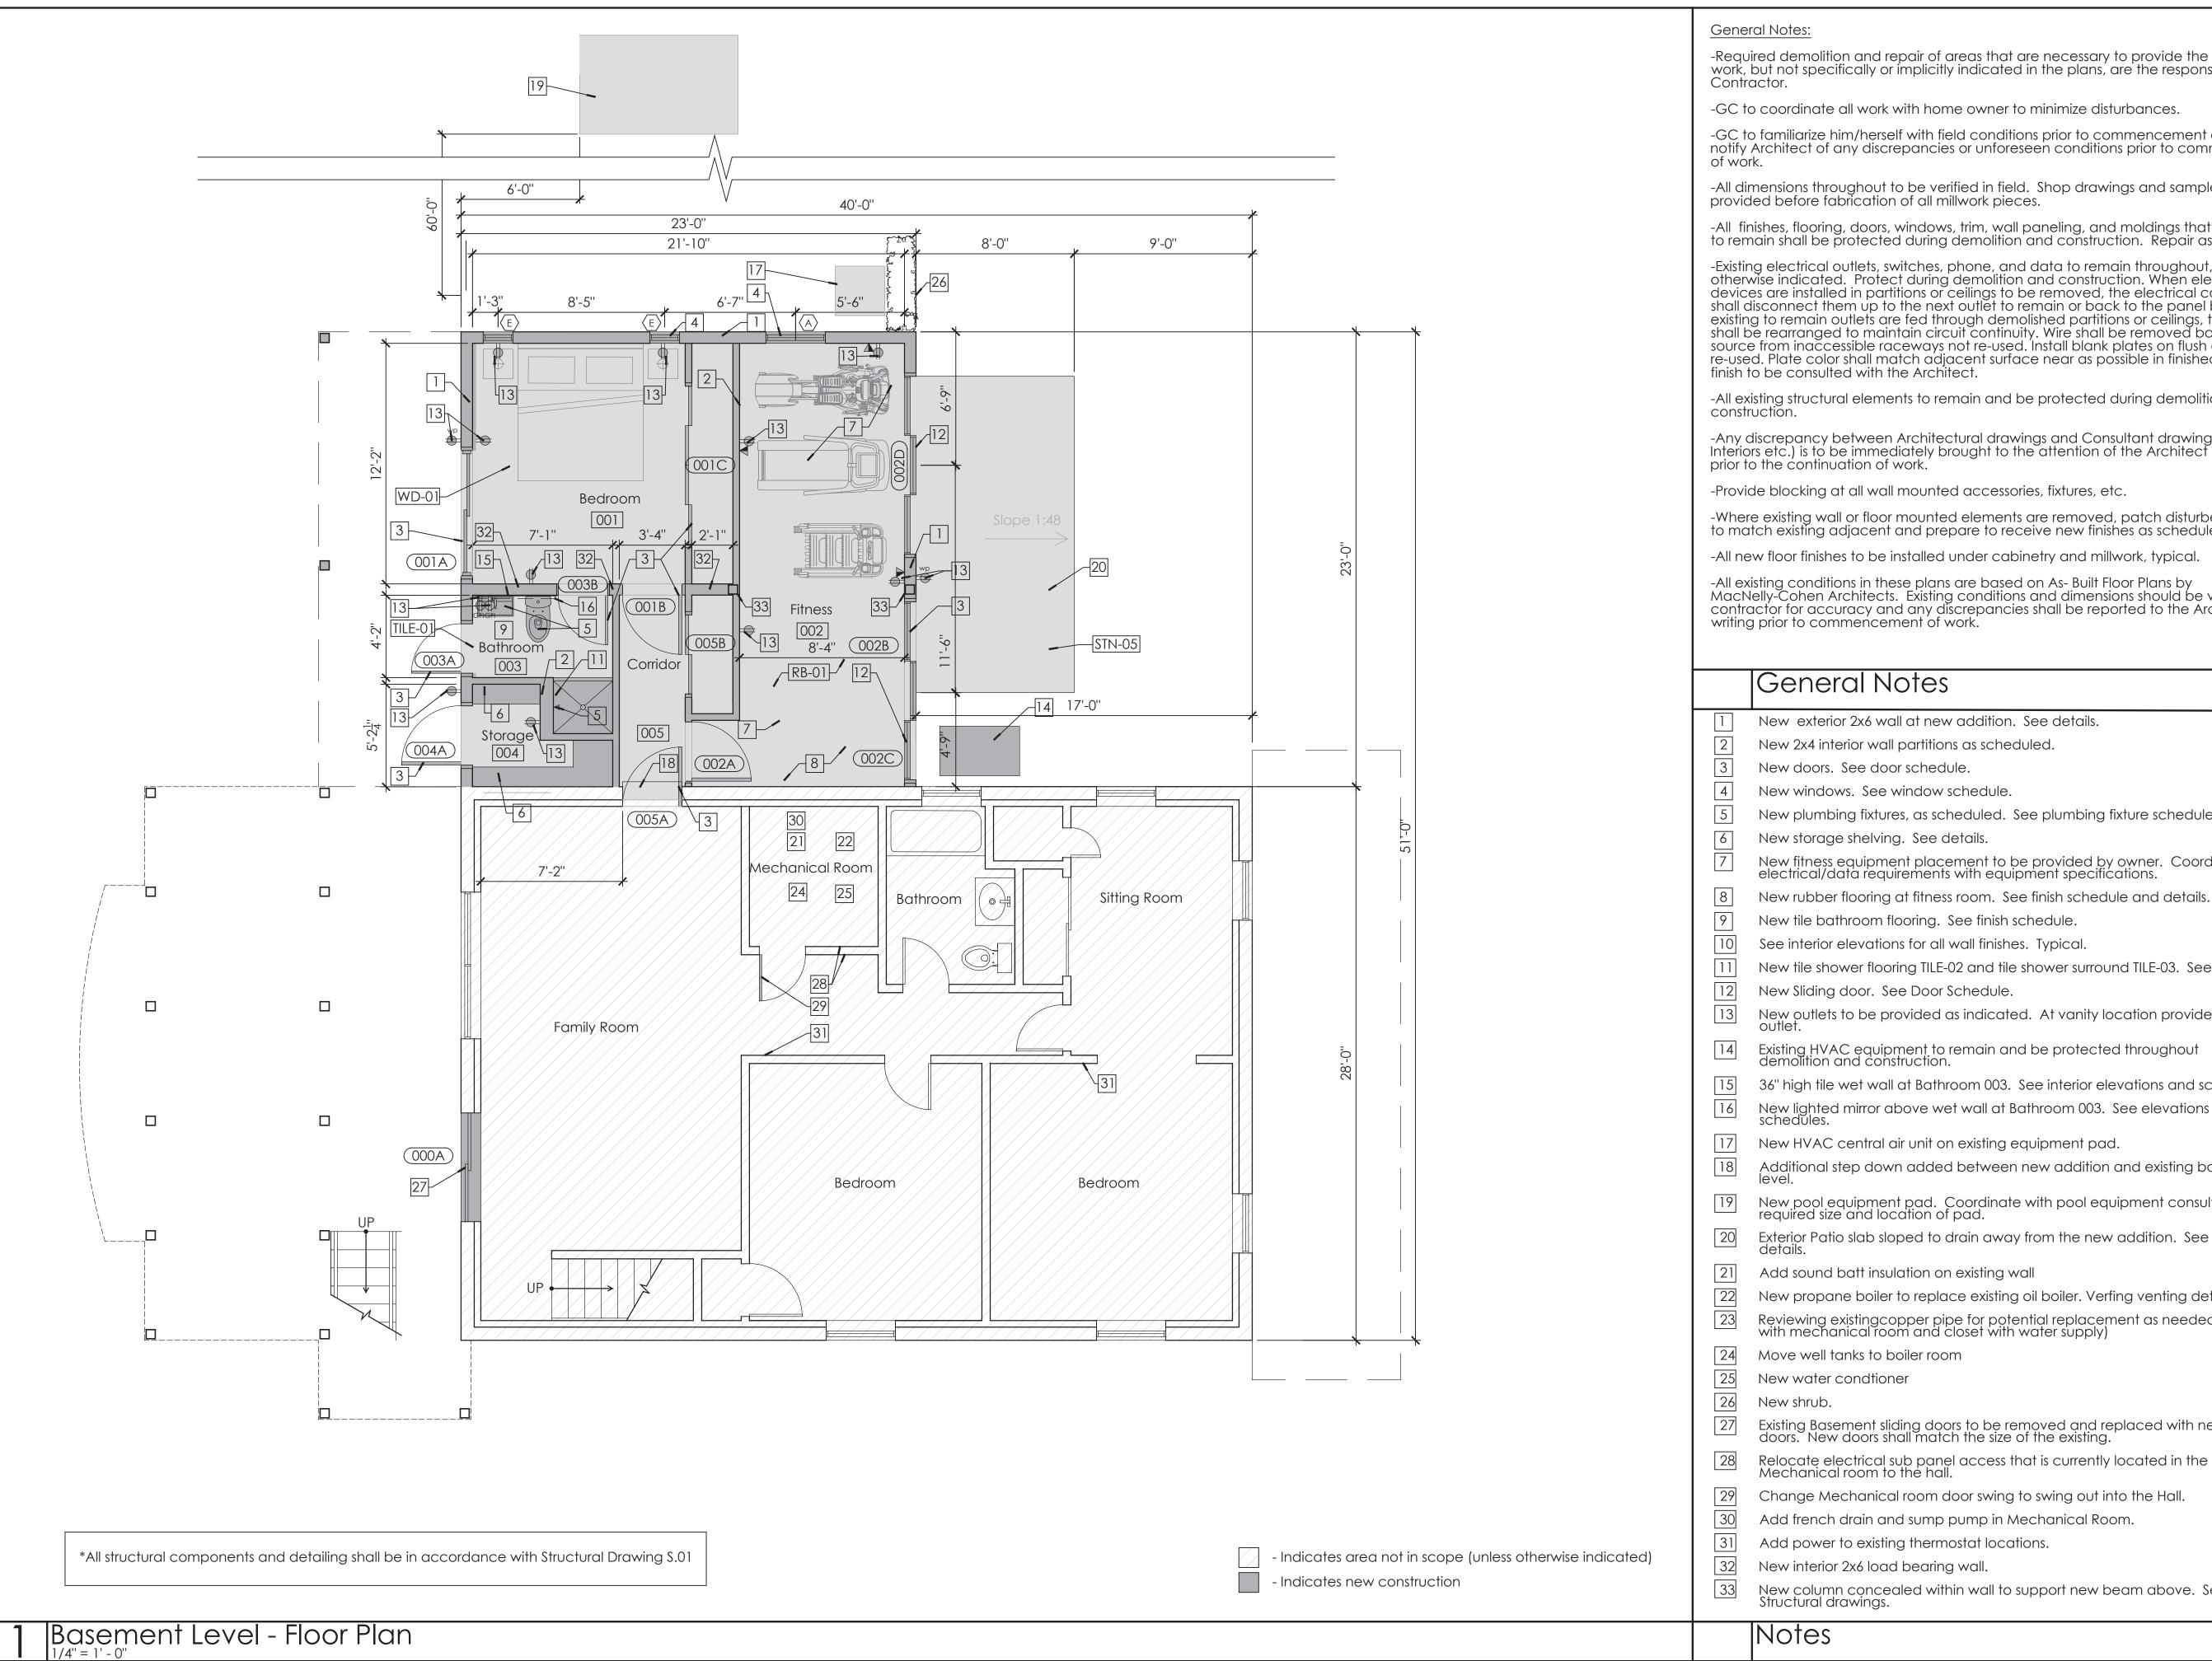-GC to coordinate all work with home owner to minimize disturbances.

-GC to familiarize him/herself with field conditions prior to commencement of work and notify Architect of any discrepancies or unforeseen conditions prior to commencement

-All dimensions throughout to be verified in field. Shop drawings and samples to be provided before fabrication of all millwork pieces.

-All finishes, flooring, doors, windows, trim, wall paneling, and moldings that are existing to remain shall be protected during demolition and construction. Repair as required.

-Existing electrical outlets, switches, phone, and data to remain throughout, unless otherwise indicated. Protect during demolition and construction. When electrical devices are installed in partitions or ceilings to be removed, the electrical contractor shall disconnect them up to the next outlet to remain or back to the panel board. If existing to remain outlets are fed through demolished partitions or ceilings, the circuit shall be rearranged to maintain circuit continuity. Wire shall be removed back to the source from inaccessible raceways not re-used. Install blank plates on flush outlets not re-used. Plate color shall match adjacent surface near as possible in finished areas. Final finish to be consulted with the Architect.

-All existing structural elements to remain and be protected during demolition and

-Any discrepancy between Architectural drawings and Consultant drawings (i.e. Interiors etc.) is to be immediately brought to the attention of the Architect in writing prior to the continuation of work.

-Provide blocking at all wall mounted accessories, fixtures, etc.

-Where existing wall or floor mounted elements are removed, patch disturbed surfaces to match existing adjacent and prepare to receive new finishes as scheduled.

-All new floor finishes to be installed under cabinetry and millwork, typical.

-All existing conditions in these plans are based on As-Built Floor Plans by MacNelly-Cohen Architects. Existing conditions and dimensions should be verified by contractor for accuracy and any discrepancies shall be reported to the Architect in writing prior to commencement of work.

- New exterior 2x6 wall at new addition. See details.
- New 2x4 interior wall partitions as scheduled.
- New doors. See door schedule.
- New windows. See window schedule.
- New plumbing fixtures, as scheduled. See plumbing fixture schedule.
- New storage shelving. See details.
- New fitness equipment placement to be provided by owner. Coordinate all electrical/data requirements with equipment specifications
- New rubber flooring at fitness room. See finish schedule and details.
- New tile bathroom flooring. See finish schedule.
- See interior elevations for all wall finishes. Typical.
- New tile shower flooring TILE-02 and tile shower surround TILE-03. See details. New Sliding door. See Door Schedule.
- New outlets to be provided as indicated. At vanity location provide GFI
- Existing HVAC equipment to remain and be protected throughout demolition and construction.
- 36" high tile wet wall at Bathroom 003. See interior elevations and schedules.
- New lighted mirror above wet wall at Bathroom 003. See elevations and
- New HVAC central air unit on existing equipment pad.
- Additional step down added between new addition and existing basment
- New pool equipment pad. Coordinate with pool equipment consultant for required size and location of pad.

- New propane boiler to replace existing oil boiler. Verfing venting detail
- Reviewing existingcopper pipe for potential replacement as needed (Start with mechanical room and closet with water supply)
- Move well tanks to boiler room
- Existing Basement sliding doors to be removed and replaced with new sliding doors. New doors shall match the size of the existing.
- Relocate electrical sub panel access that is currently located in the Mechanical room to the hall.
- Change Mechanical room door swing to swing out into the Hall.
- Add french drain and sump pump in Mechanical Room.
- Add power to existing thermostat locations.
- New interior 2x6 load bearing wall.
- New column concealed within wall to support new beam above. See Structural drawings.

# Hirsh Residence

Master Bedroom Suite and Basement Addition

12 Brook Hollow Road West Tisbury, MA 02575




González Architects Residential




14 NE First Avenue STE 500 Miami FL 33132 T +1 (305) 455 4216

Drawing No.

Basement Level Floor Plan

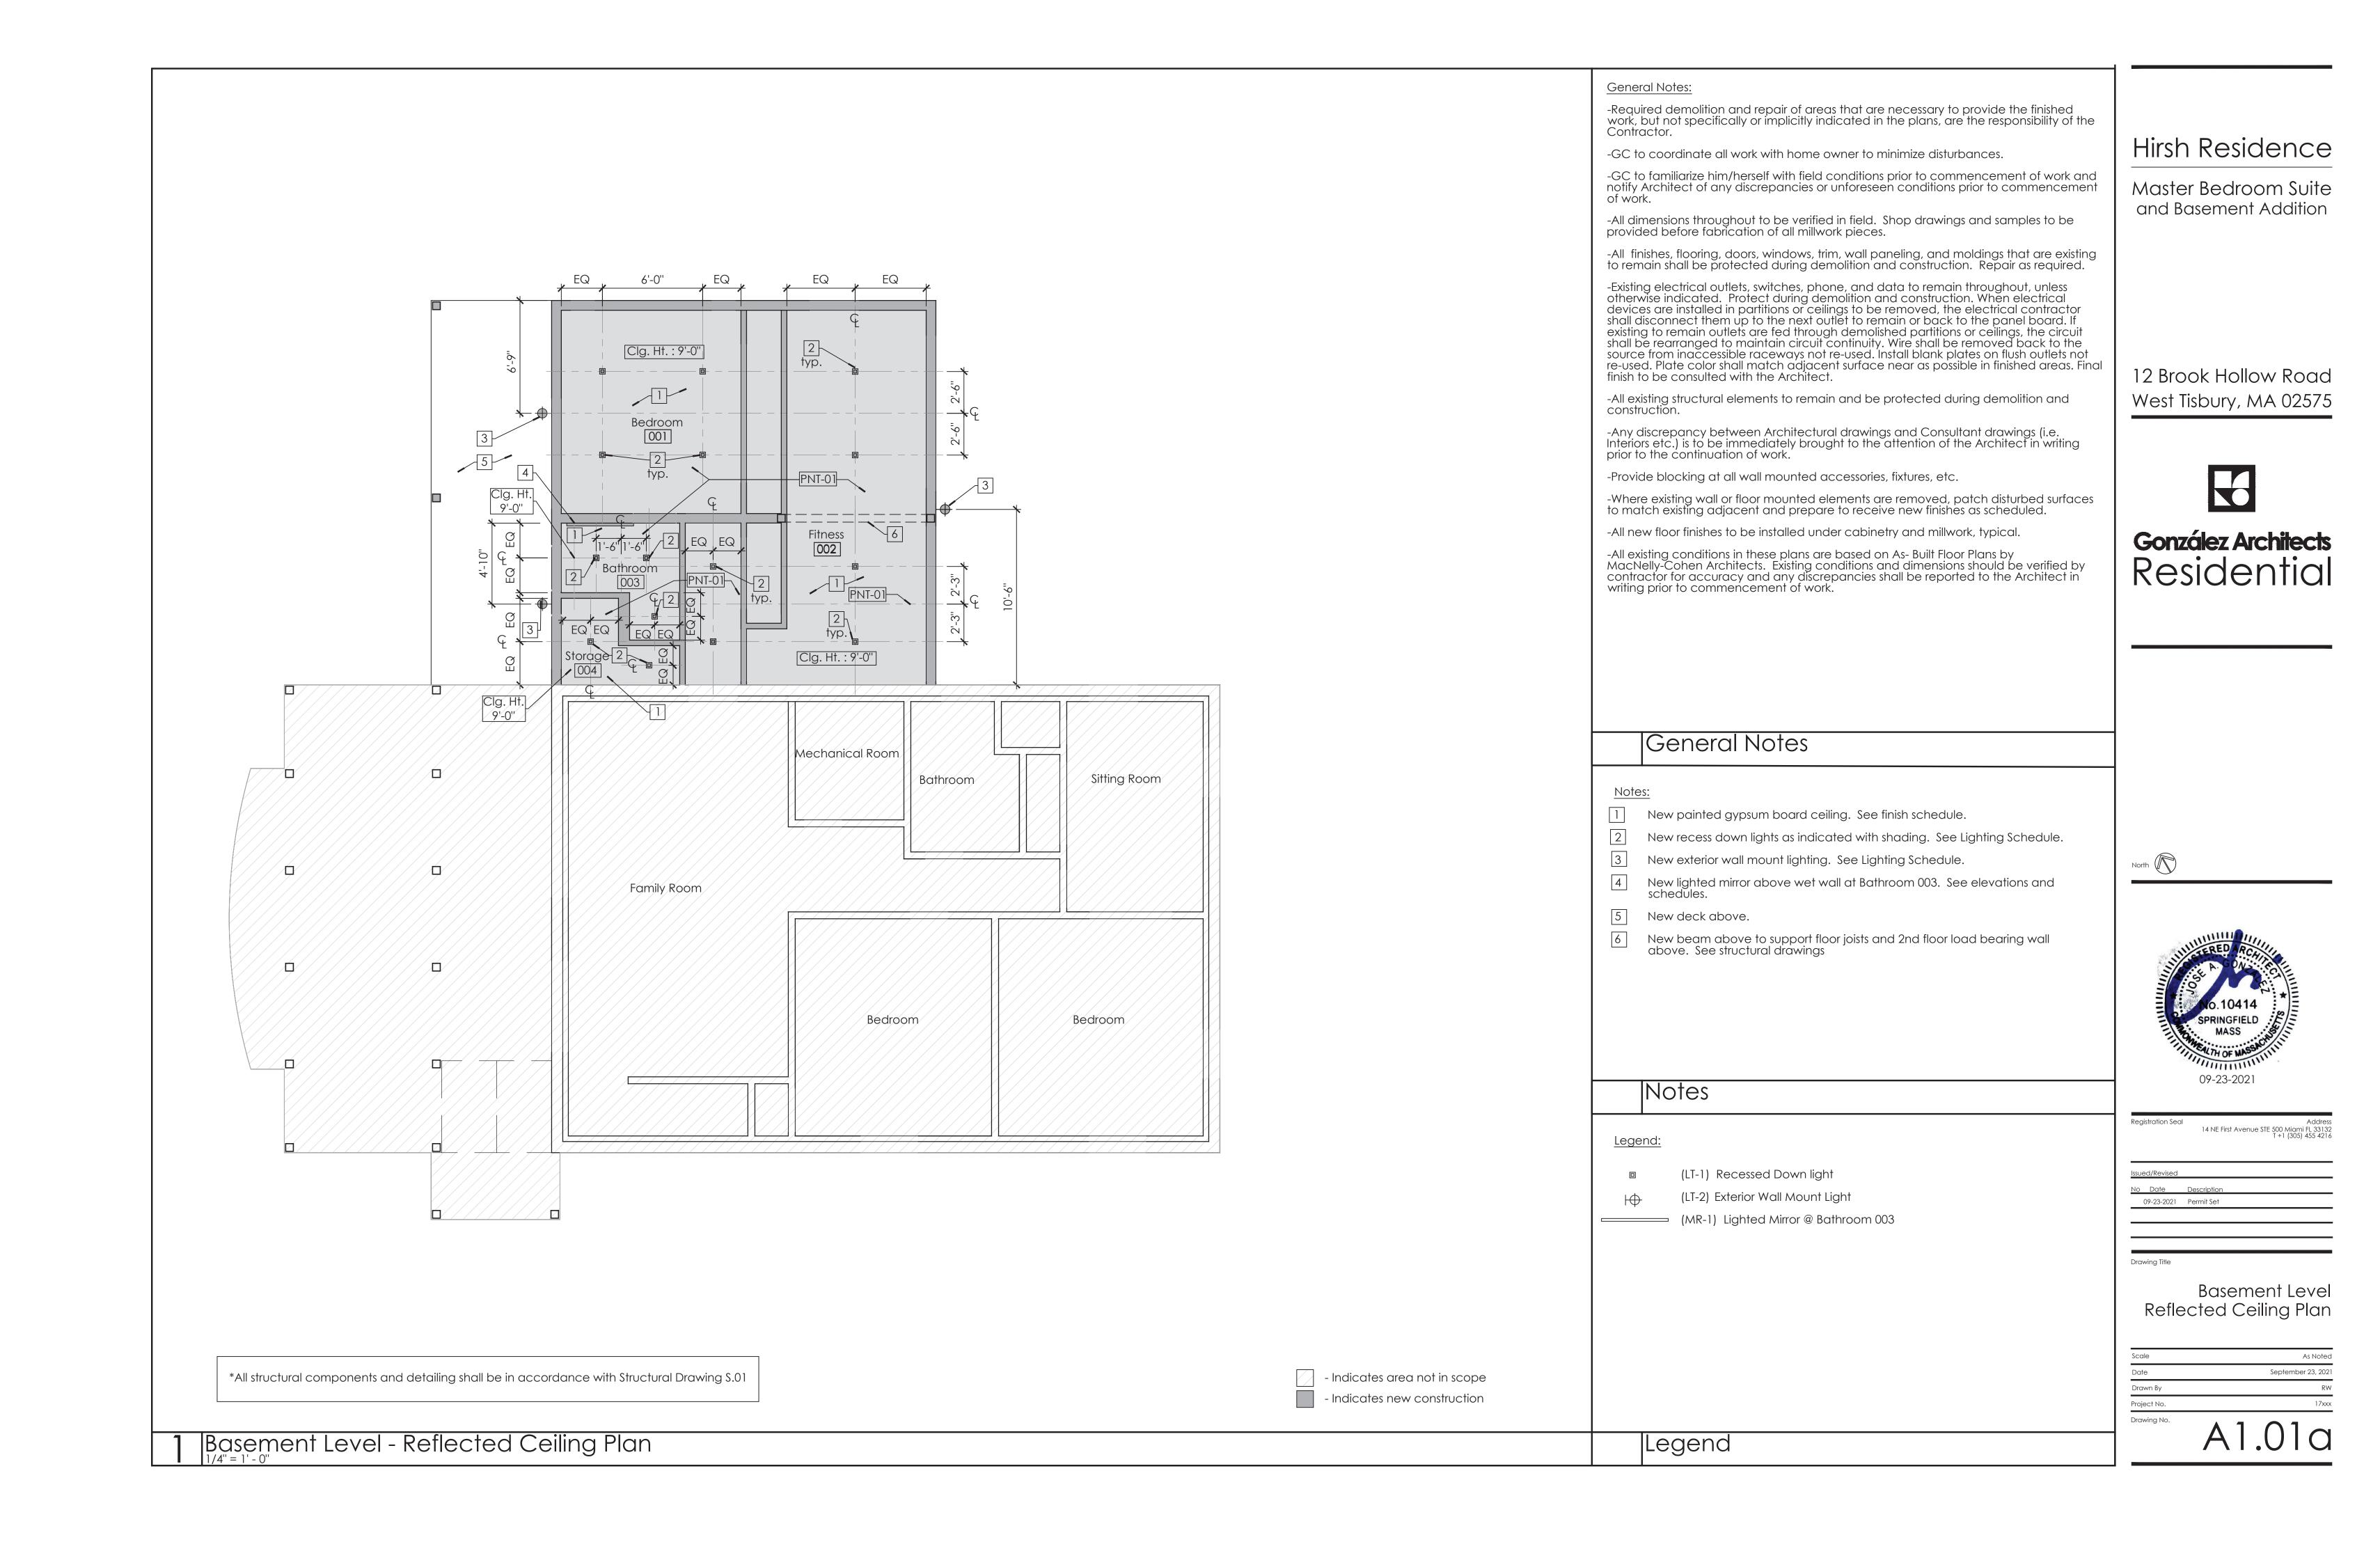

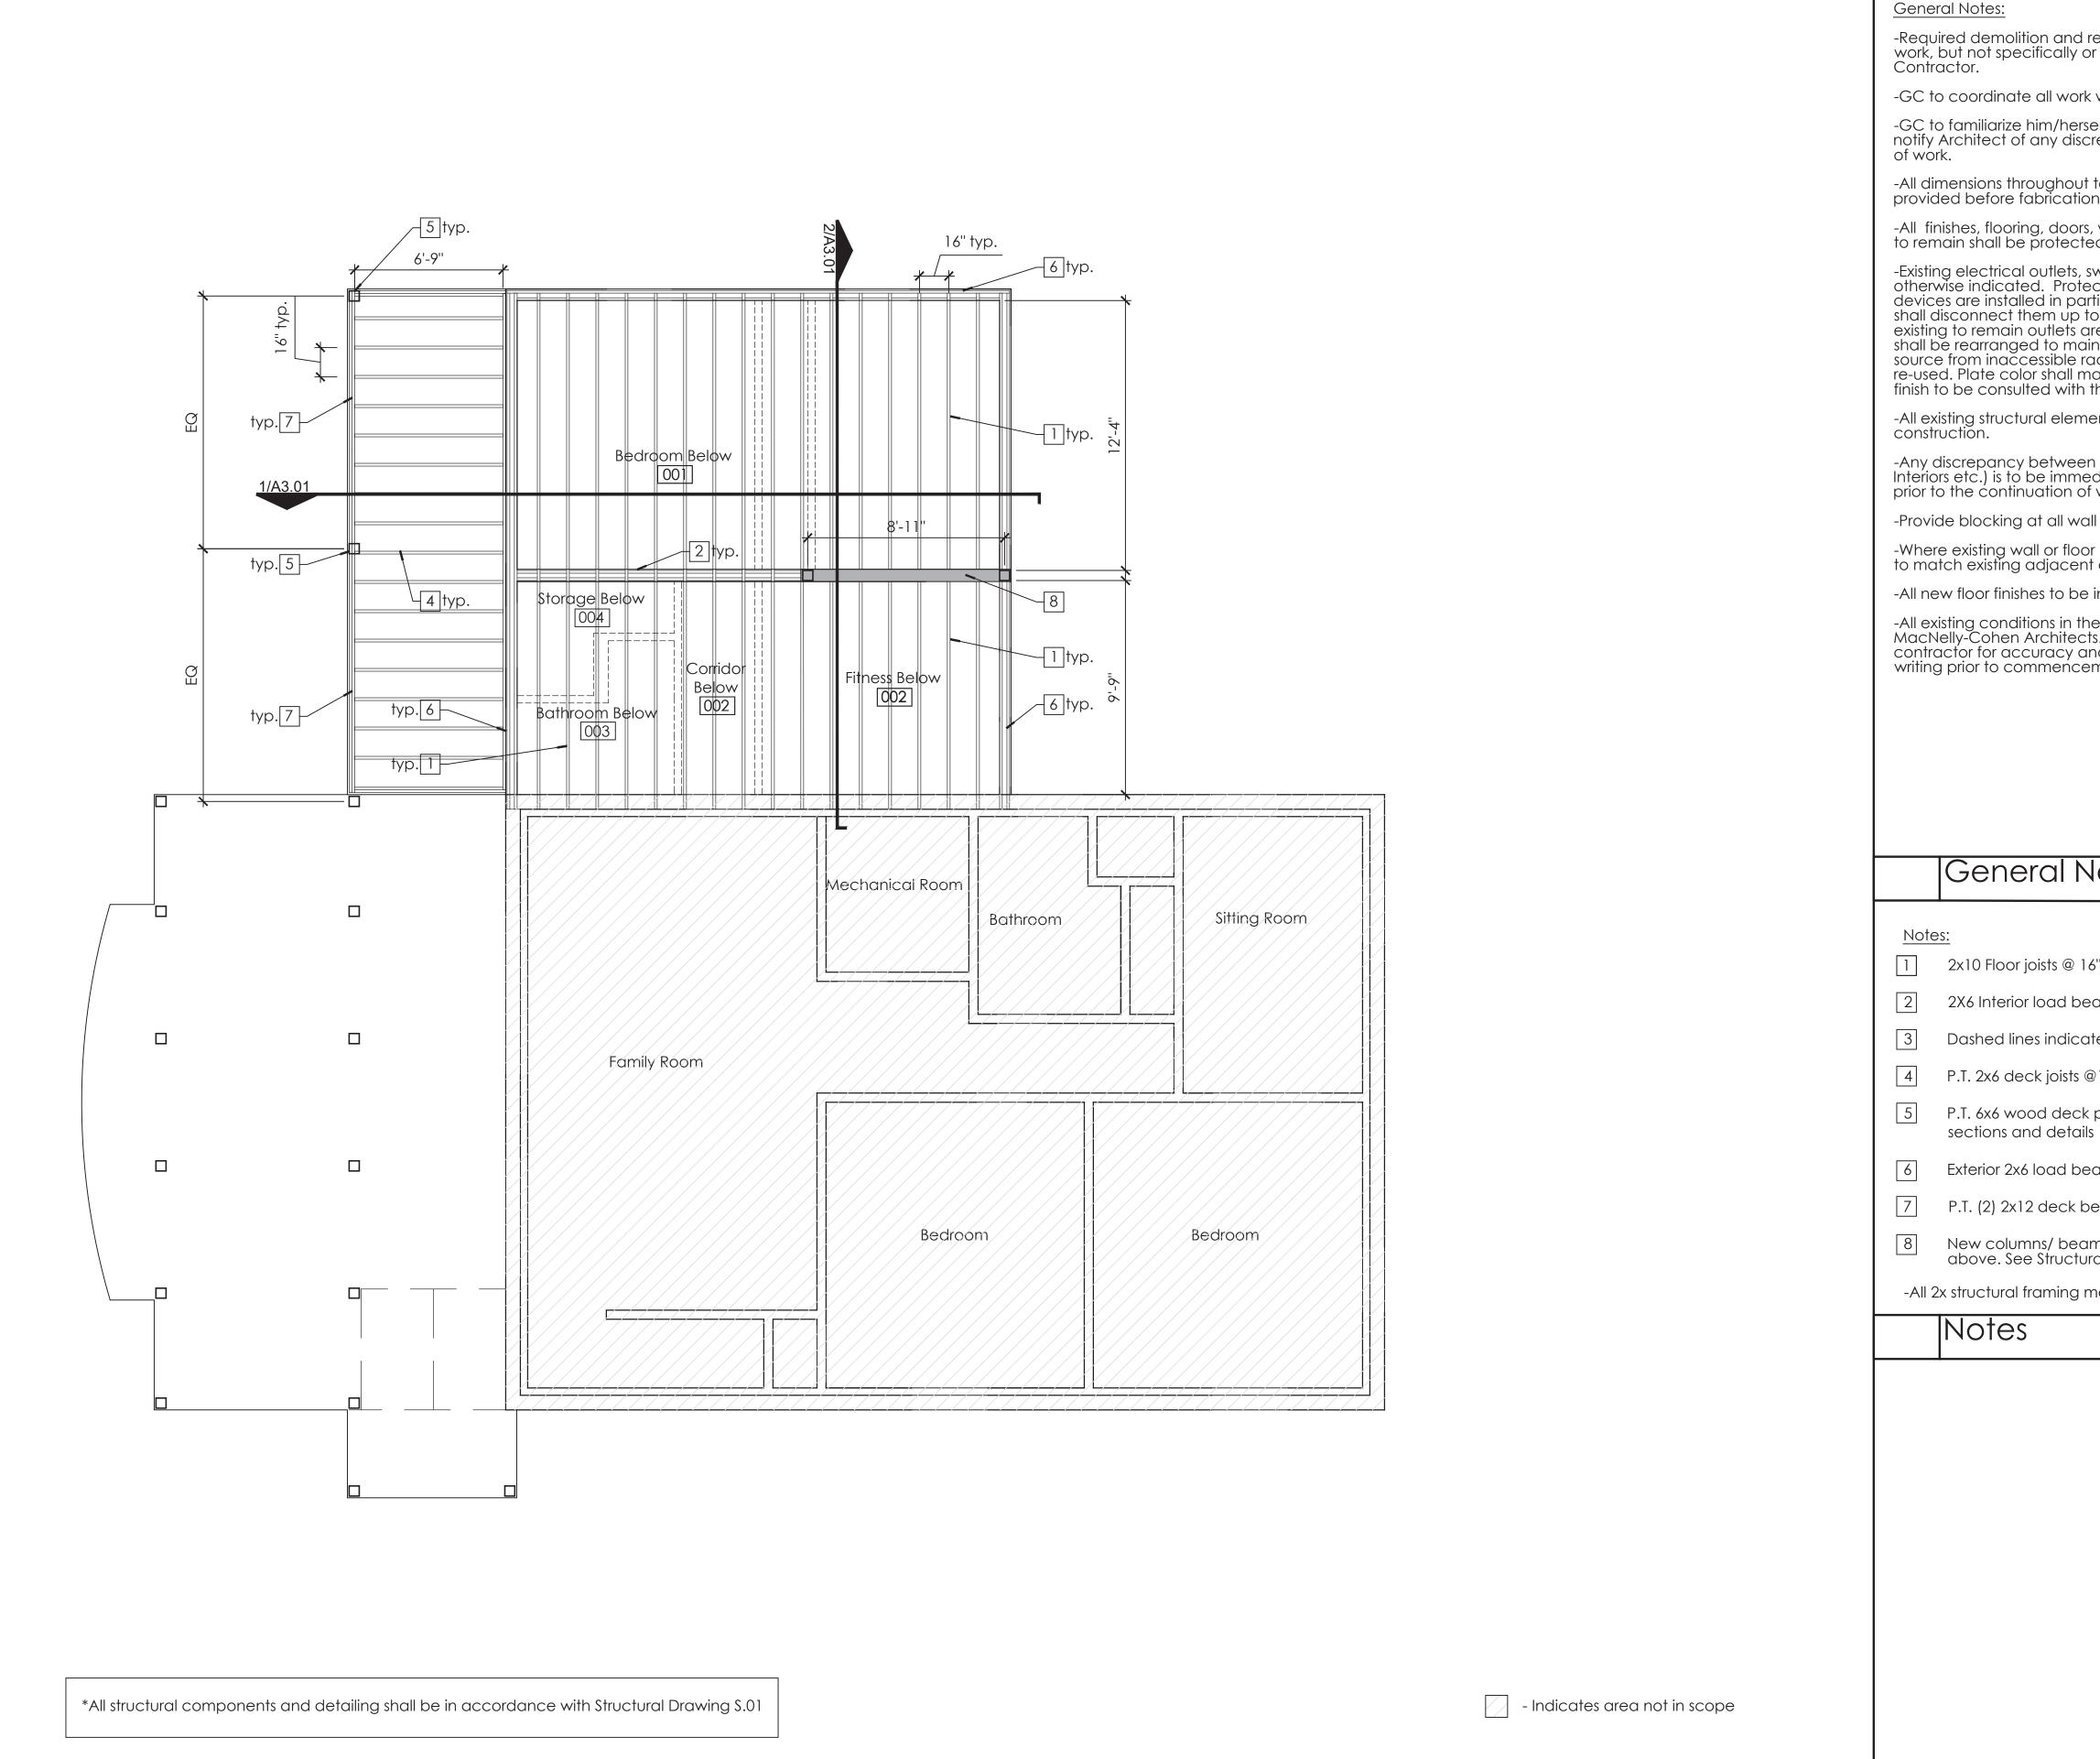

First Level - Framing Plan

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#### General Notes

2x10 Floor joists @ 16" O.C.

2X6 Interior load bearing stud wall @16" o.c.

Dashed lines indicate non-load bearing partitions below.

P.T. 2x6 deck joists @16" o.c.

P.T. 6x6 wood deck post to match existing adjacent deck construction. See

Exterior 2x6 load bearing wall. See sections and details.

P.T. (2) 2x12 deck beam.

New columns/ beam to support floor joists and 2nd floor load bearing wall above. See Structural drawings.

-All 2x structural framing members to be Douglas Fir Larch, #1 or better.

## Hirsh Residence

Master Bedroom Suite and Basement Addition

12 Brook Hollow Road West Tisbury, MA 02575




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First Level Framing Plan



Master Bedroom Suite and Basement Addition

12 Brook Hollow Road West Tisbury, MA 02575

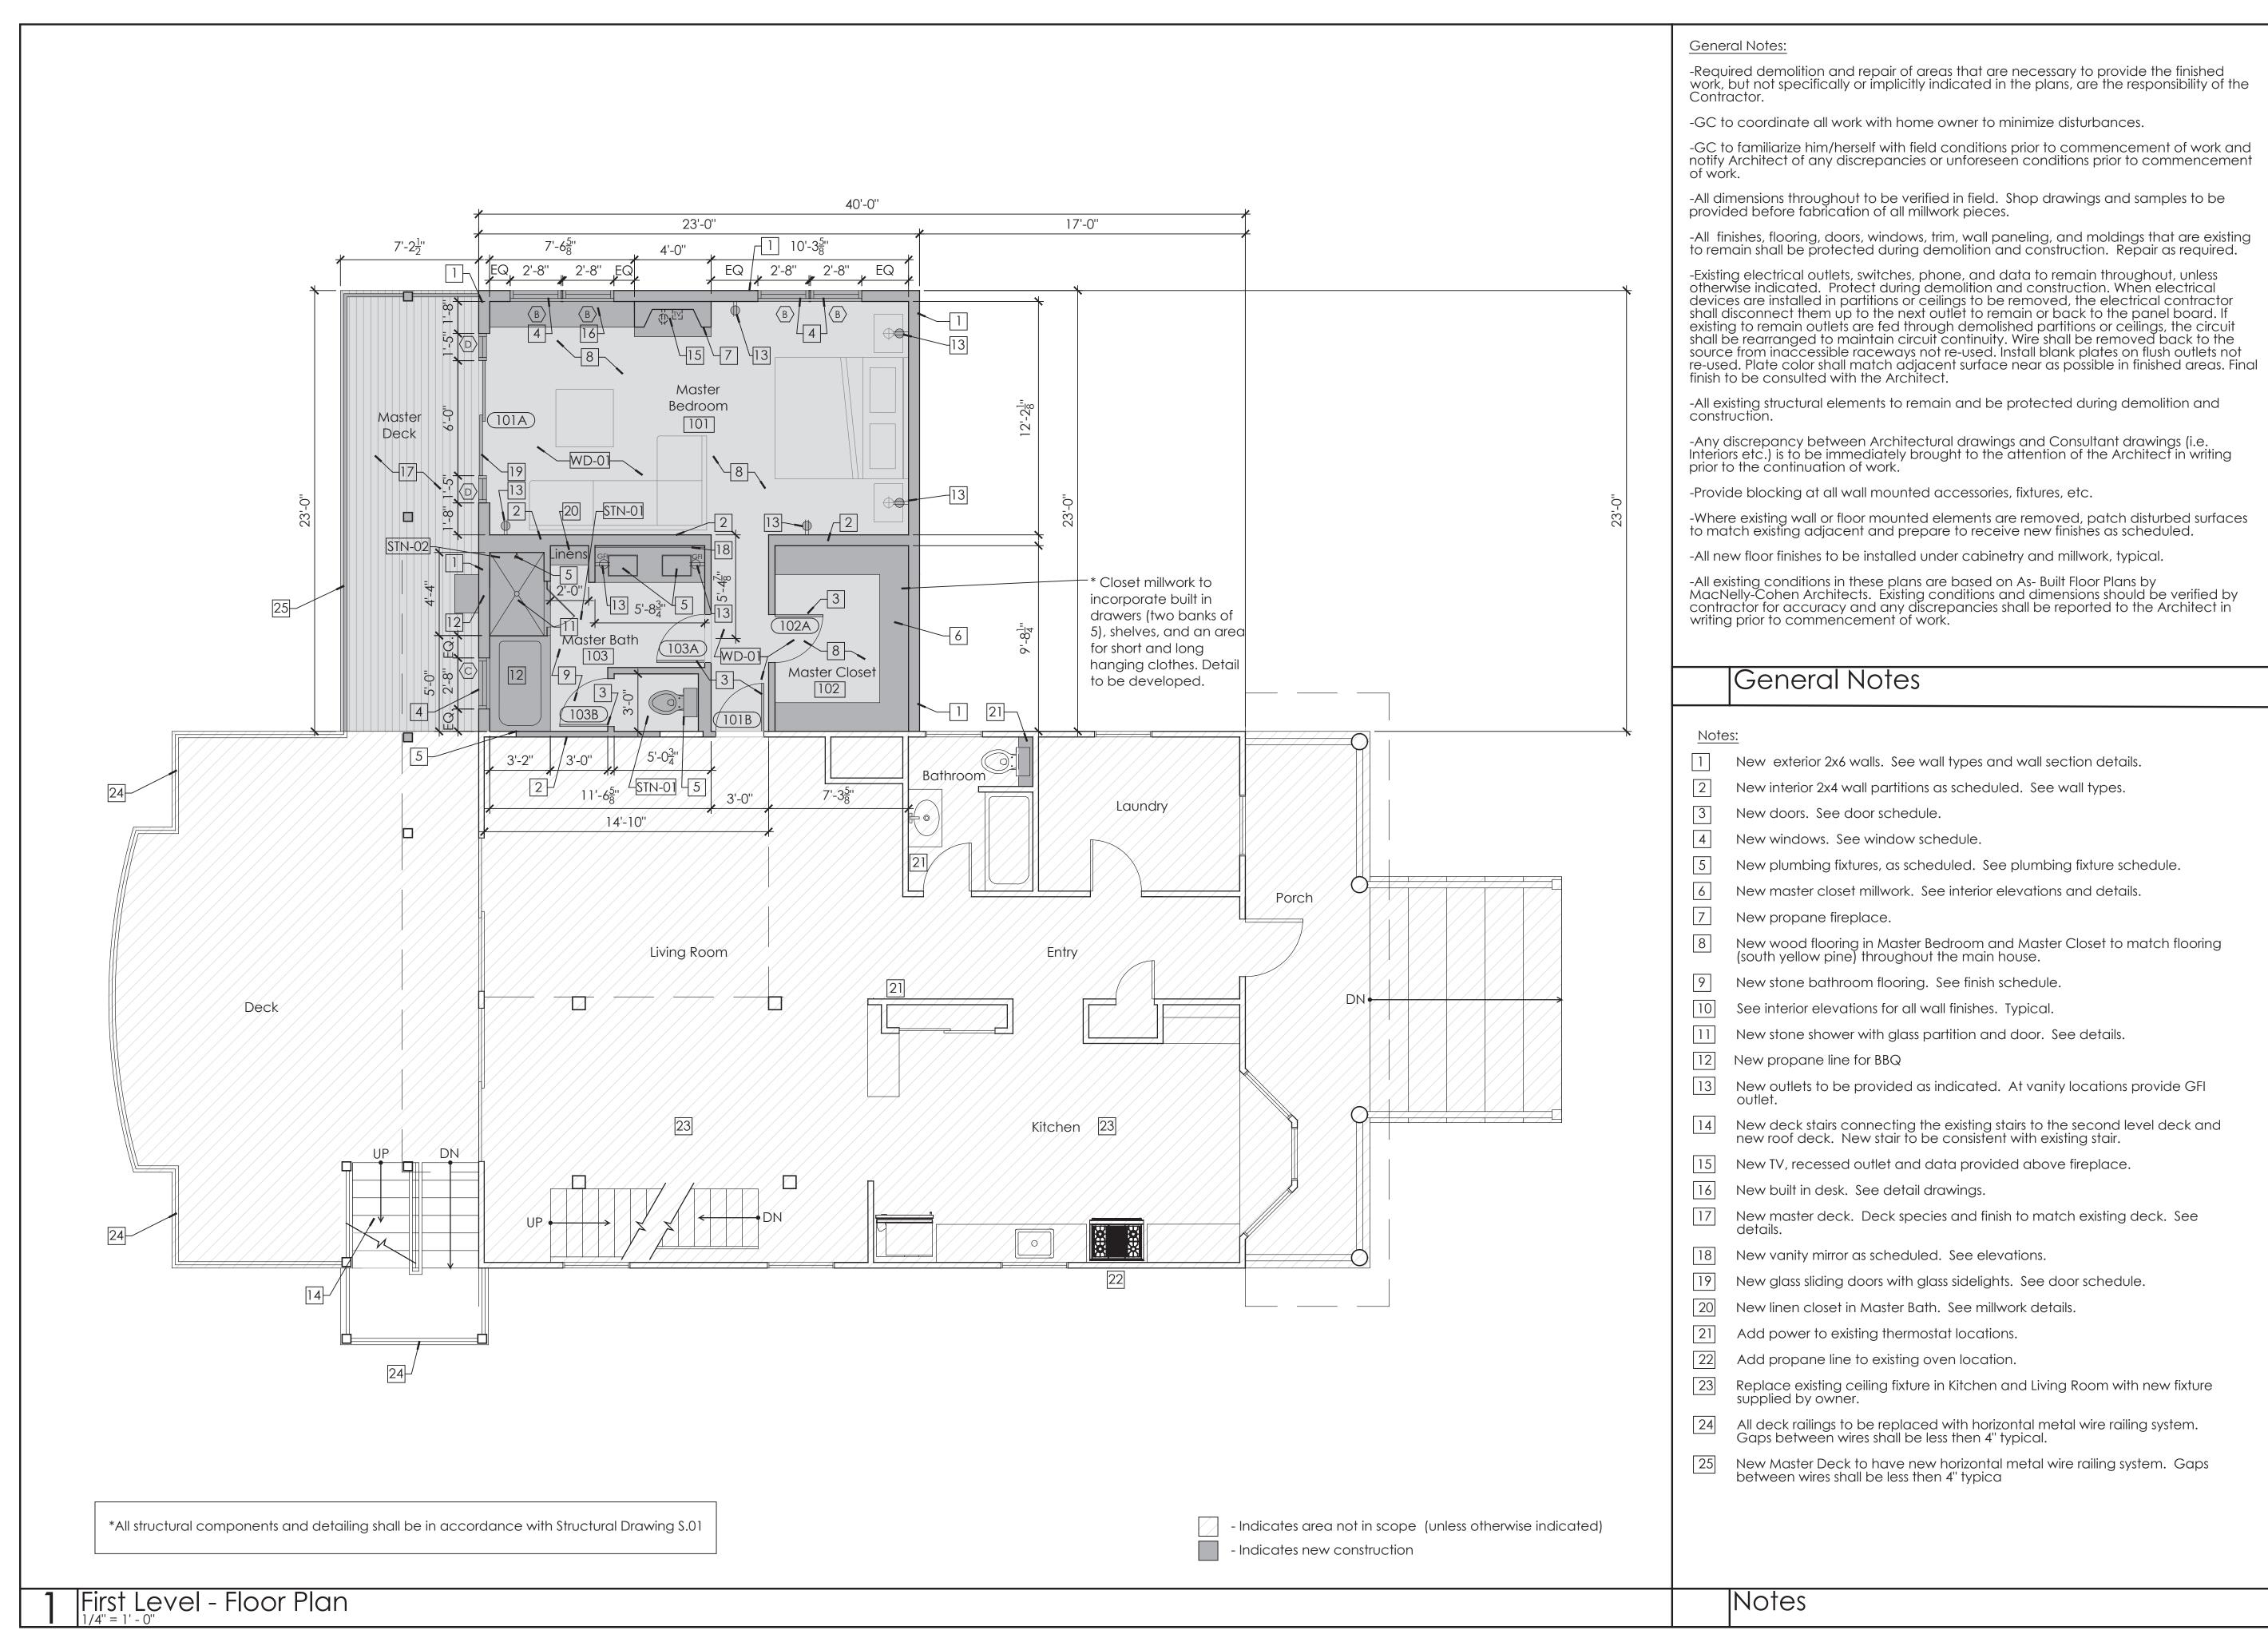

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Address

14 NE First Avenue STE 500 Miami FL 33132
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First Level

Floor Plan

As Noted

Scale As Noted


Date September 23, 2021

Drawn By RW

Project No. 17xxx

Drawing No.

A1.02

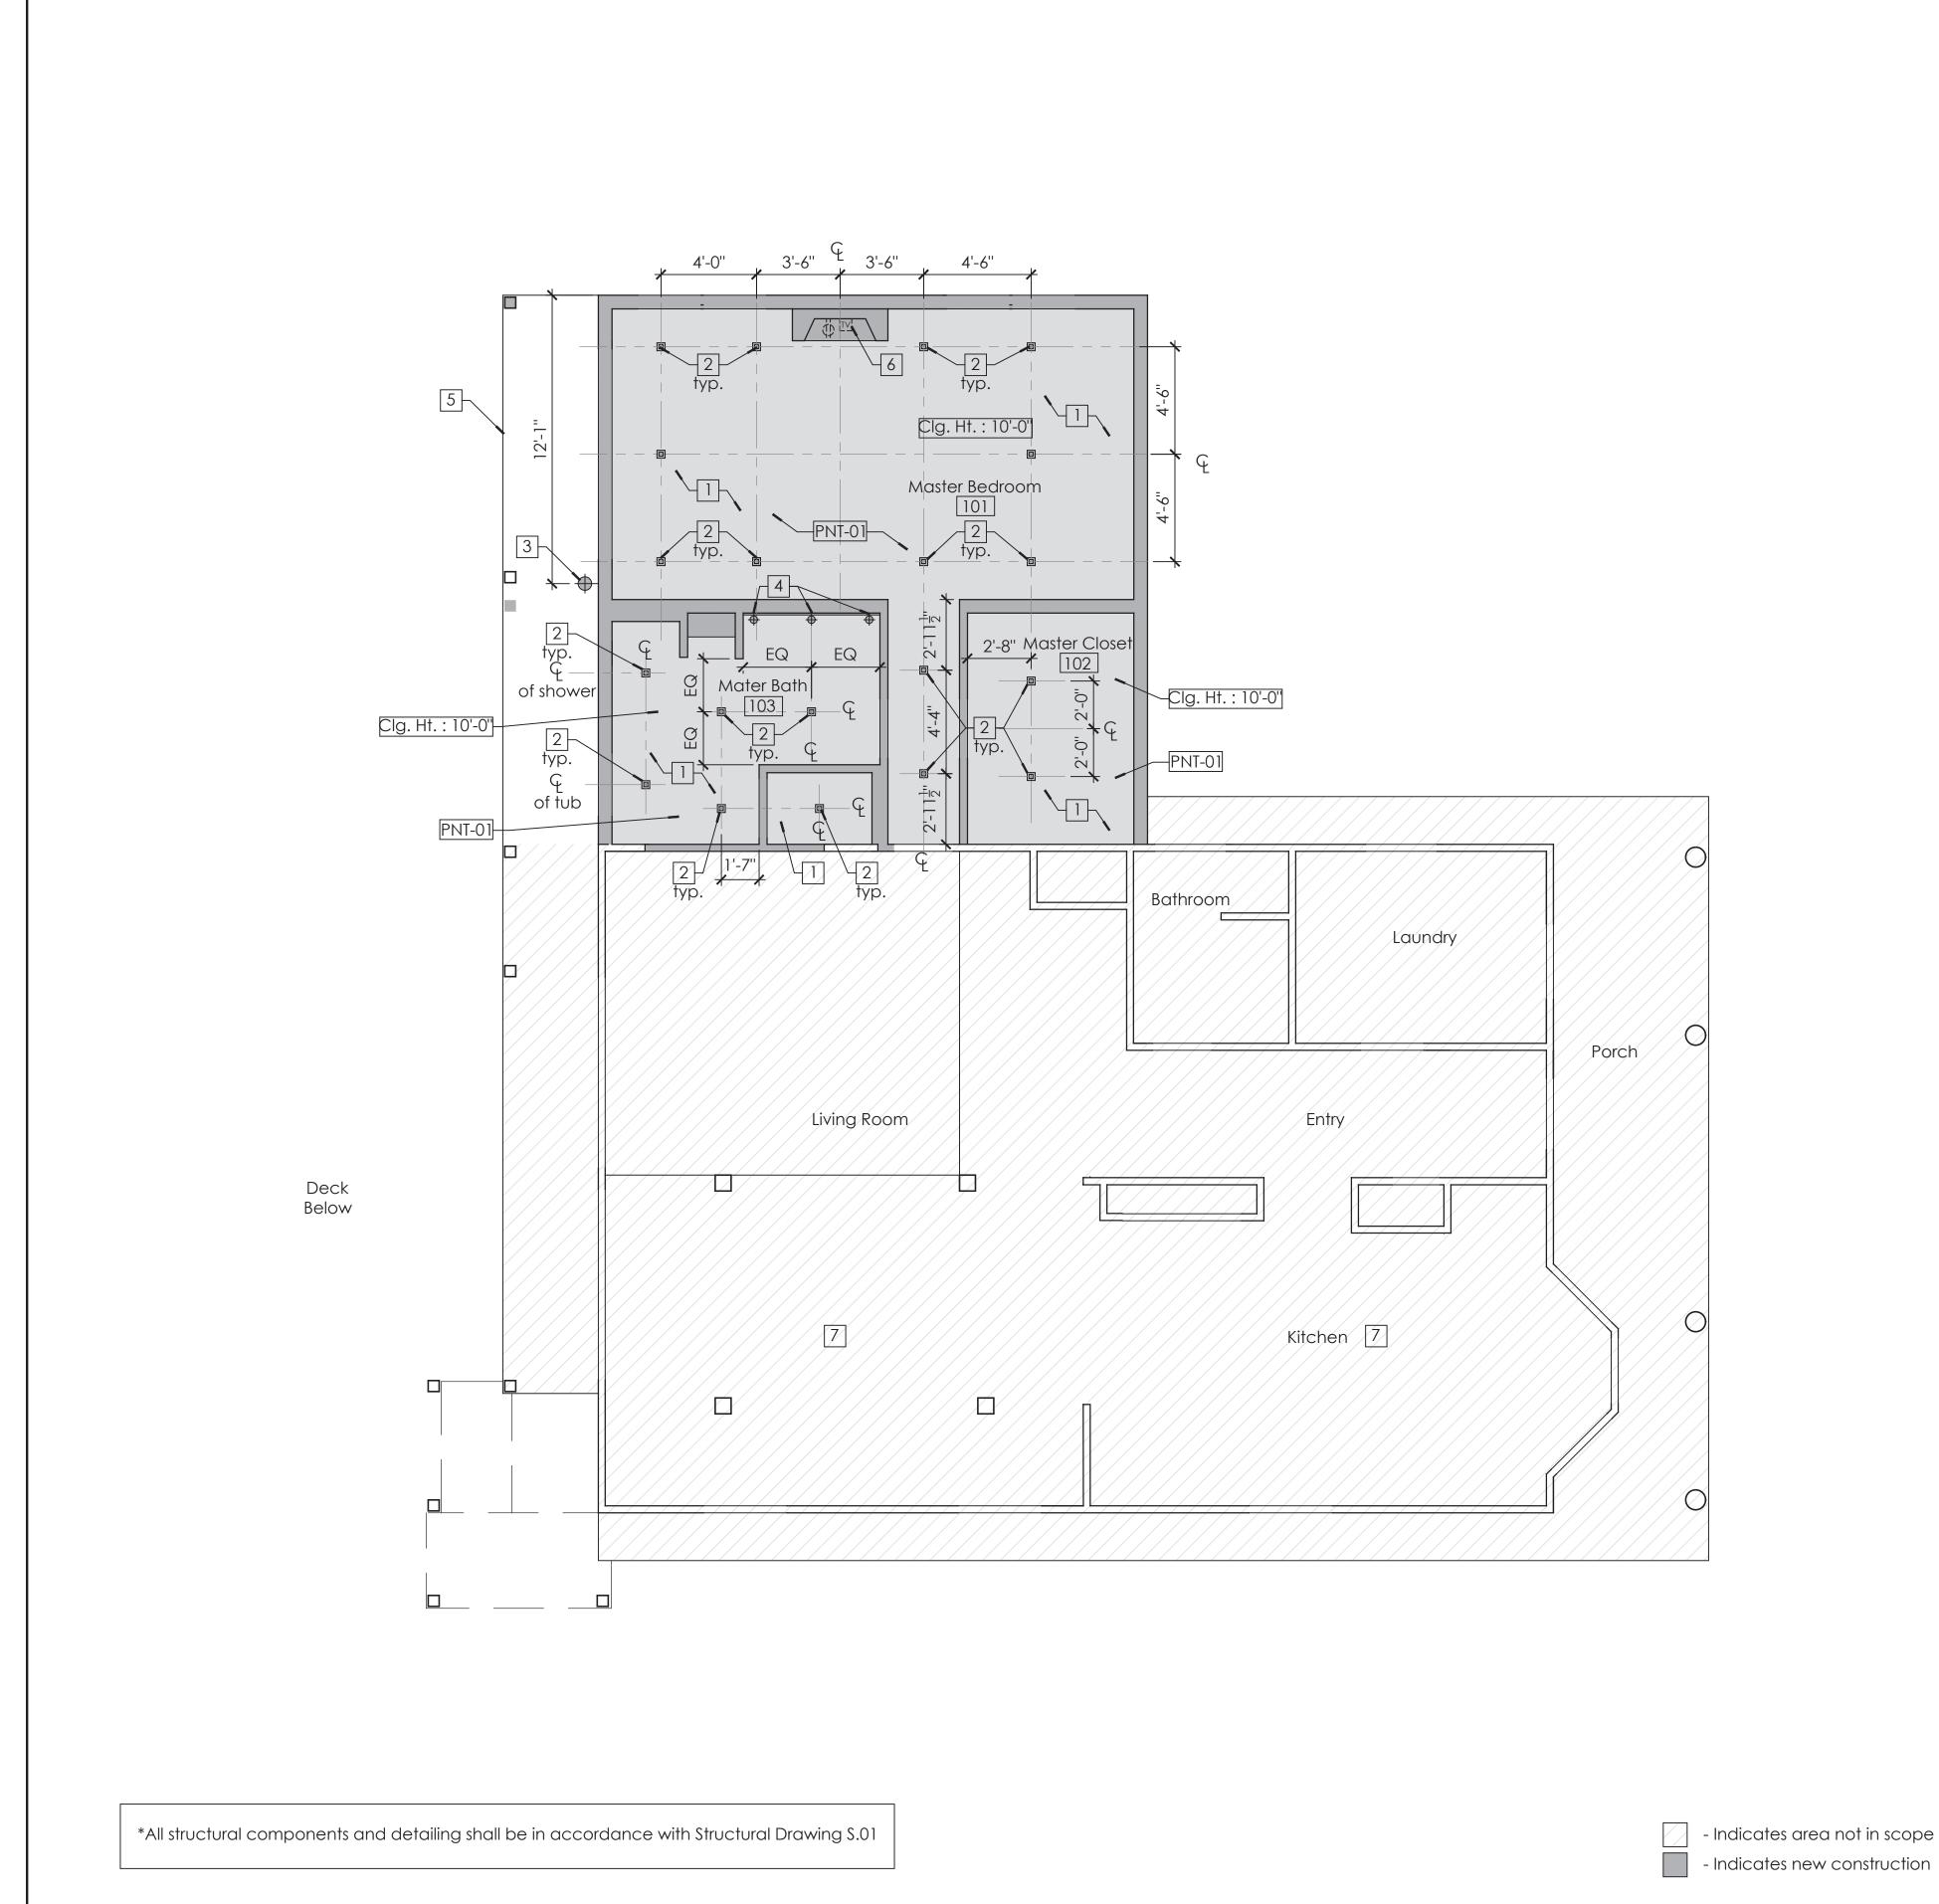

-Required demolition and repair of areas that are necessary to provide the finished work, but not specifically or implicitly indicated in the plans, are the responsibility of the Contractor.

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-All existing structural elements to remain and be protected during demolition and construction.

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-All new floor finishes to be installed under cabinetry and millwork, typical.

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#### Hirsh Residence

Master Bedroom Suite and Basement Addition

12 Brook Hollow Road West Tisbury, MA 02575



González Architects Residential

#### General Notes

#### Notes:

New painted gypsum board ceiling. See finish schedule.

2 New recess down lights as indicated with shading. See Lighting Schedule.

New exterior wall mount lighting. See Lighting Schedule.

4 New Sconces @ Master Bathroom 103 Vanity.

New deck above.

New TV, recessed outlet and data provided above fireplace.

Replace existing ceiling fixture in Kitchen and Living Room with new fixture supplied by owner.

#### North



#### Notes

#### Legend:

(LT-1) Recessed Down light

(LT-2) Exterior Wall Mount Light

(LT-3) Sconces @ Master Bathroom 103 Vanity

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No Date Description

09-23-2021 Permit Set

Drawing Title

First Level Reflected Ceiling Plan

Scale As Noted

Date September 23, 2021


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Project No. 17xxx

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Legend

First Level - Reflected Ceiling Plan



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-All new floor finishes to be installed under cabinetry and millwork, typical.
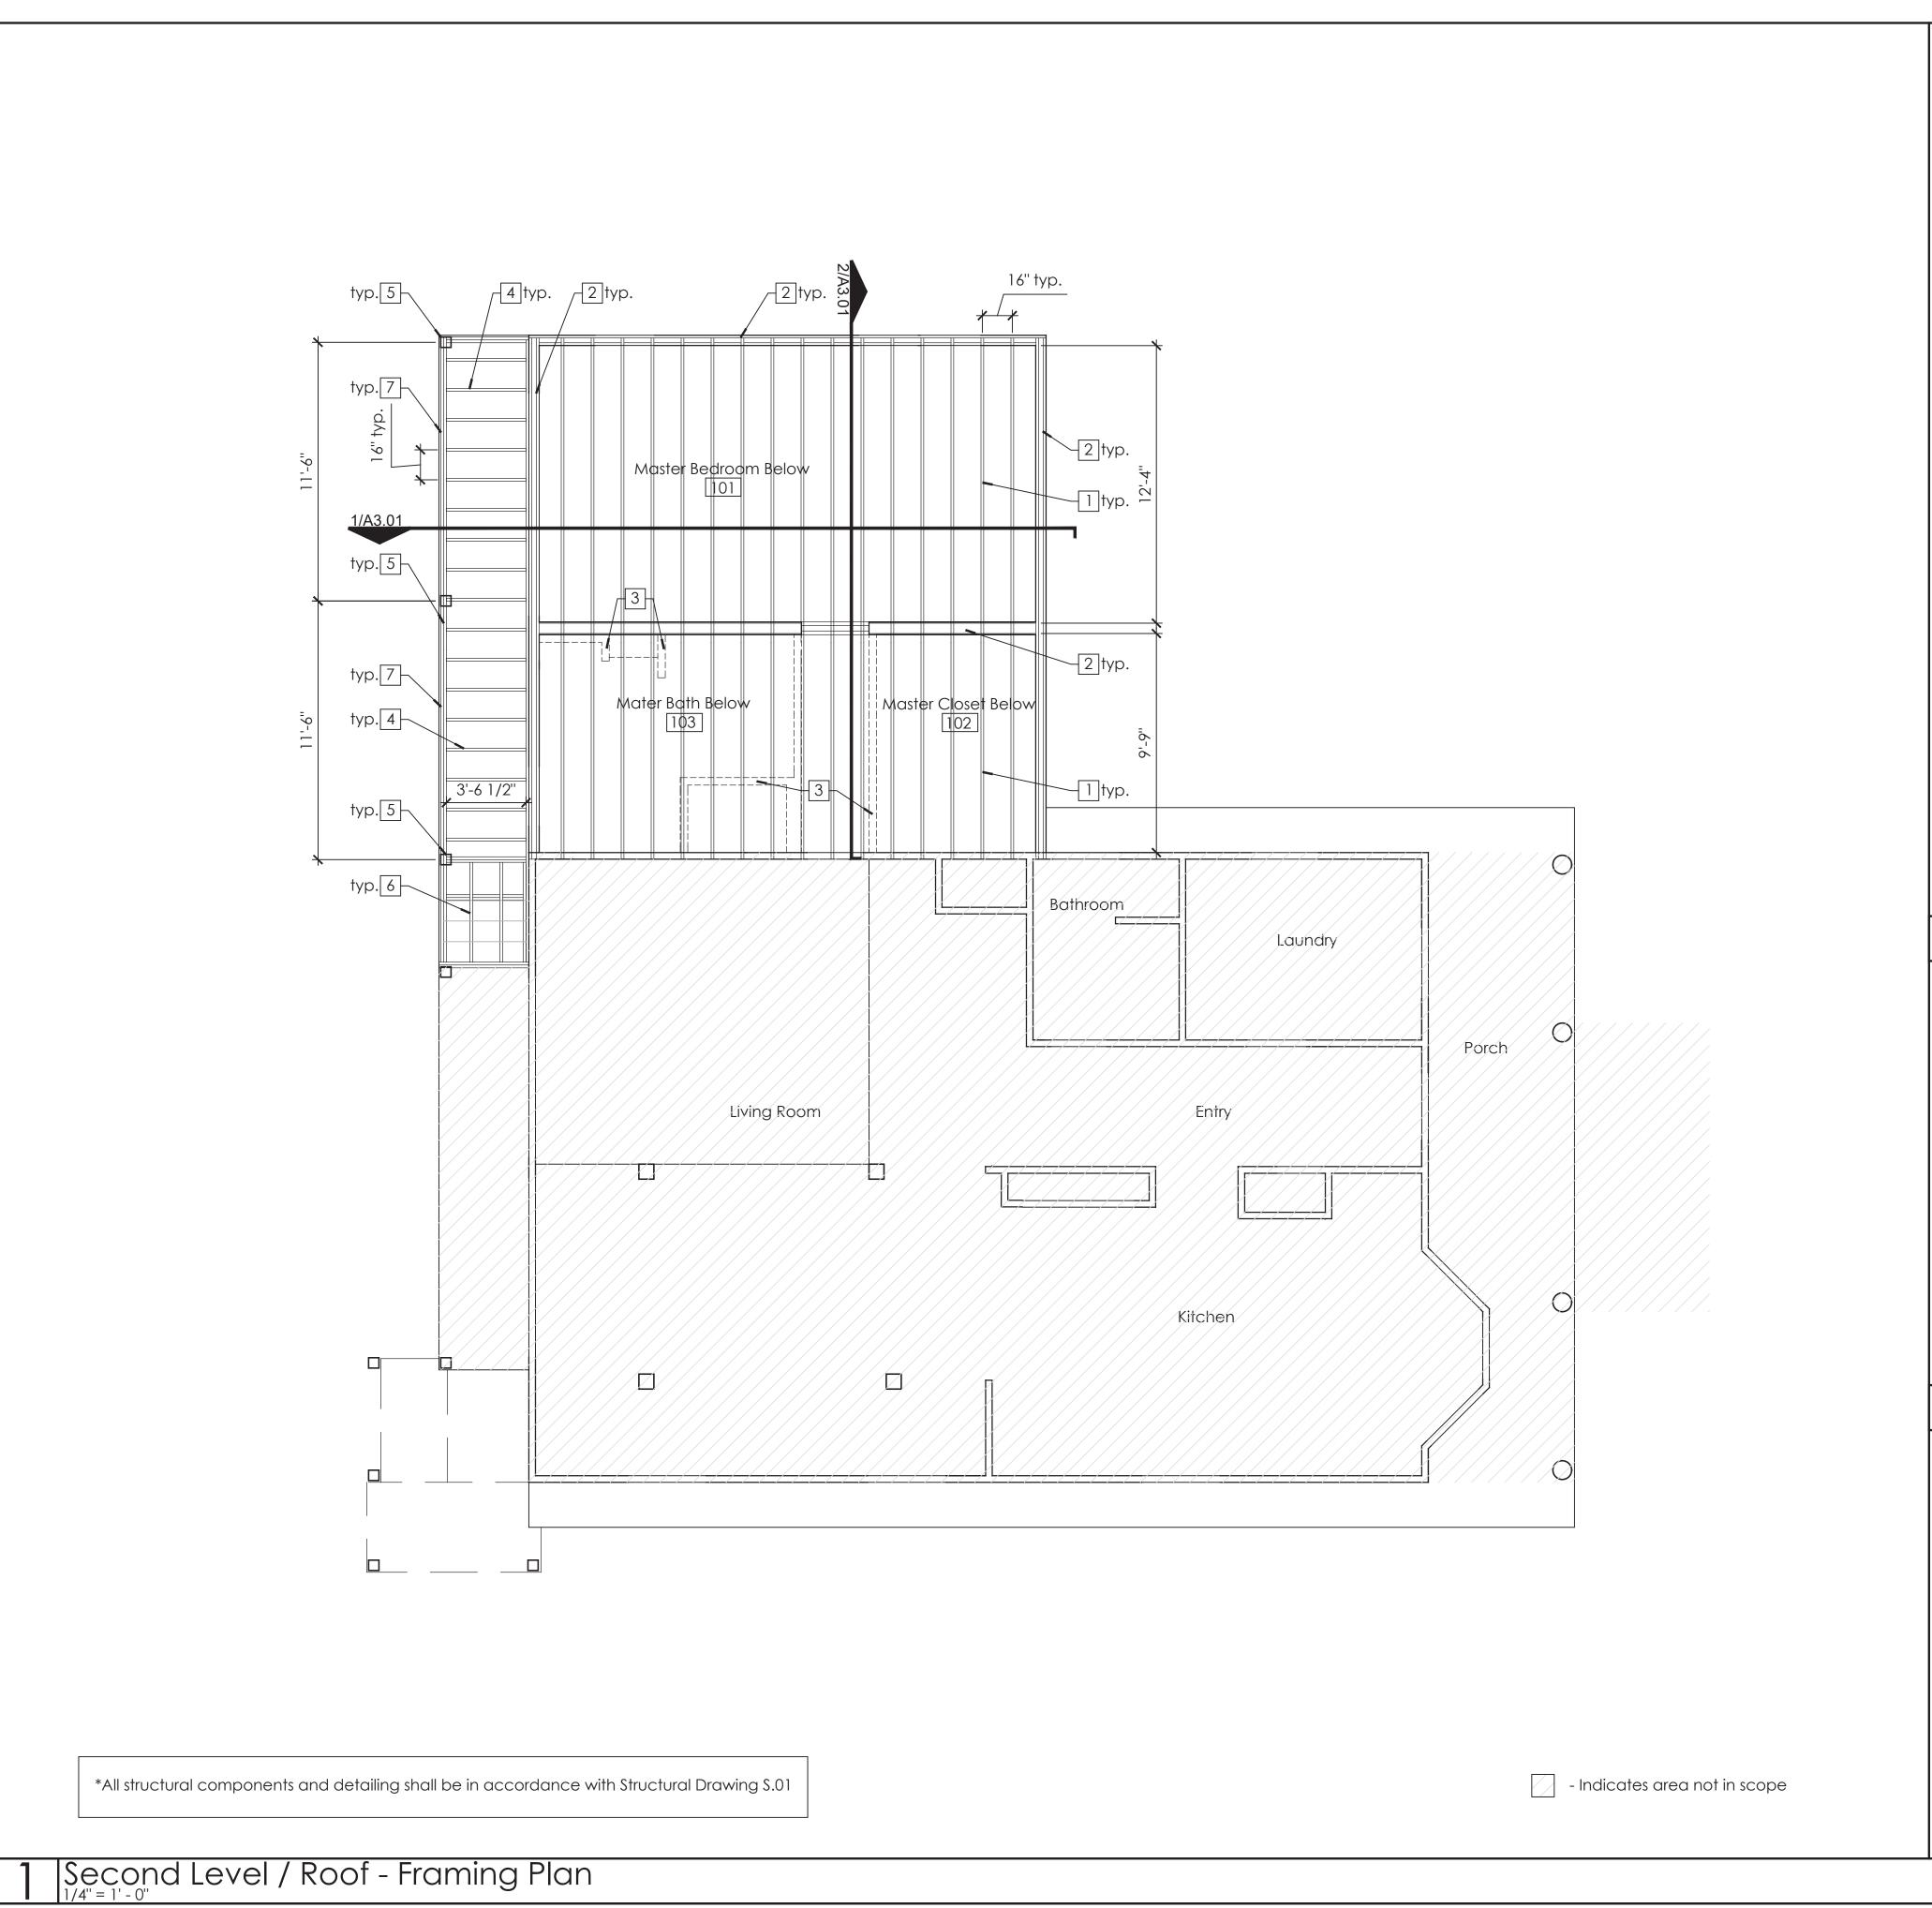
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#### General Notes

#### Notes:

1 2x10 Roof joists @ 12" O.C.

2 2X6 Load bearing stud wall @16" o.c.

3 Dashed lines indicate non-load bearing partitions below.

4 P.T. 2x6 deck joists @16" o.c.

5 P.T. 6x6 wood deck post to match existing adjacent deck construction.

6 P.T. 2x stair carriages and stringers. See stair details.

7 P.T. (2) 2x12 deck beam.

-All 2x structural framing members to be Douglas Fir Larch, #1 or better.

#### Notes

14 NE First Avenue STE 500 Miami FL 33132 T +1 (305) 455 4216

North

Issued/Revised

No Date Description

Hirsh Residence

Master Bedroom Suite

and Basement Addition

12 Brook Hollow Road

West Tisbury, MA 02575

**González Architects** 

Residential

Drawing Title

First Level/Roof Framing Plan


Scale As Noted

Date September 23, 2021

Drawn By RW

Project No. 17xxx

A1.02b

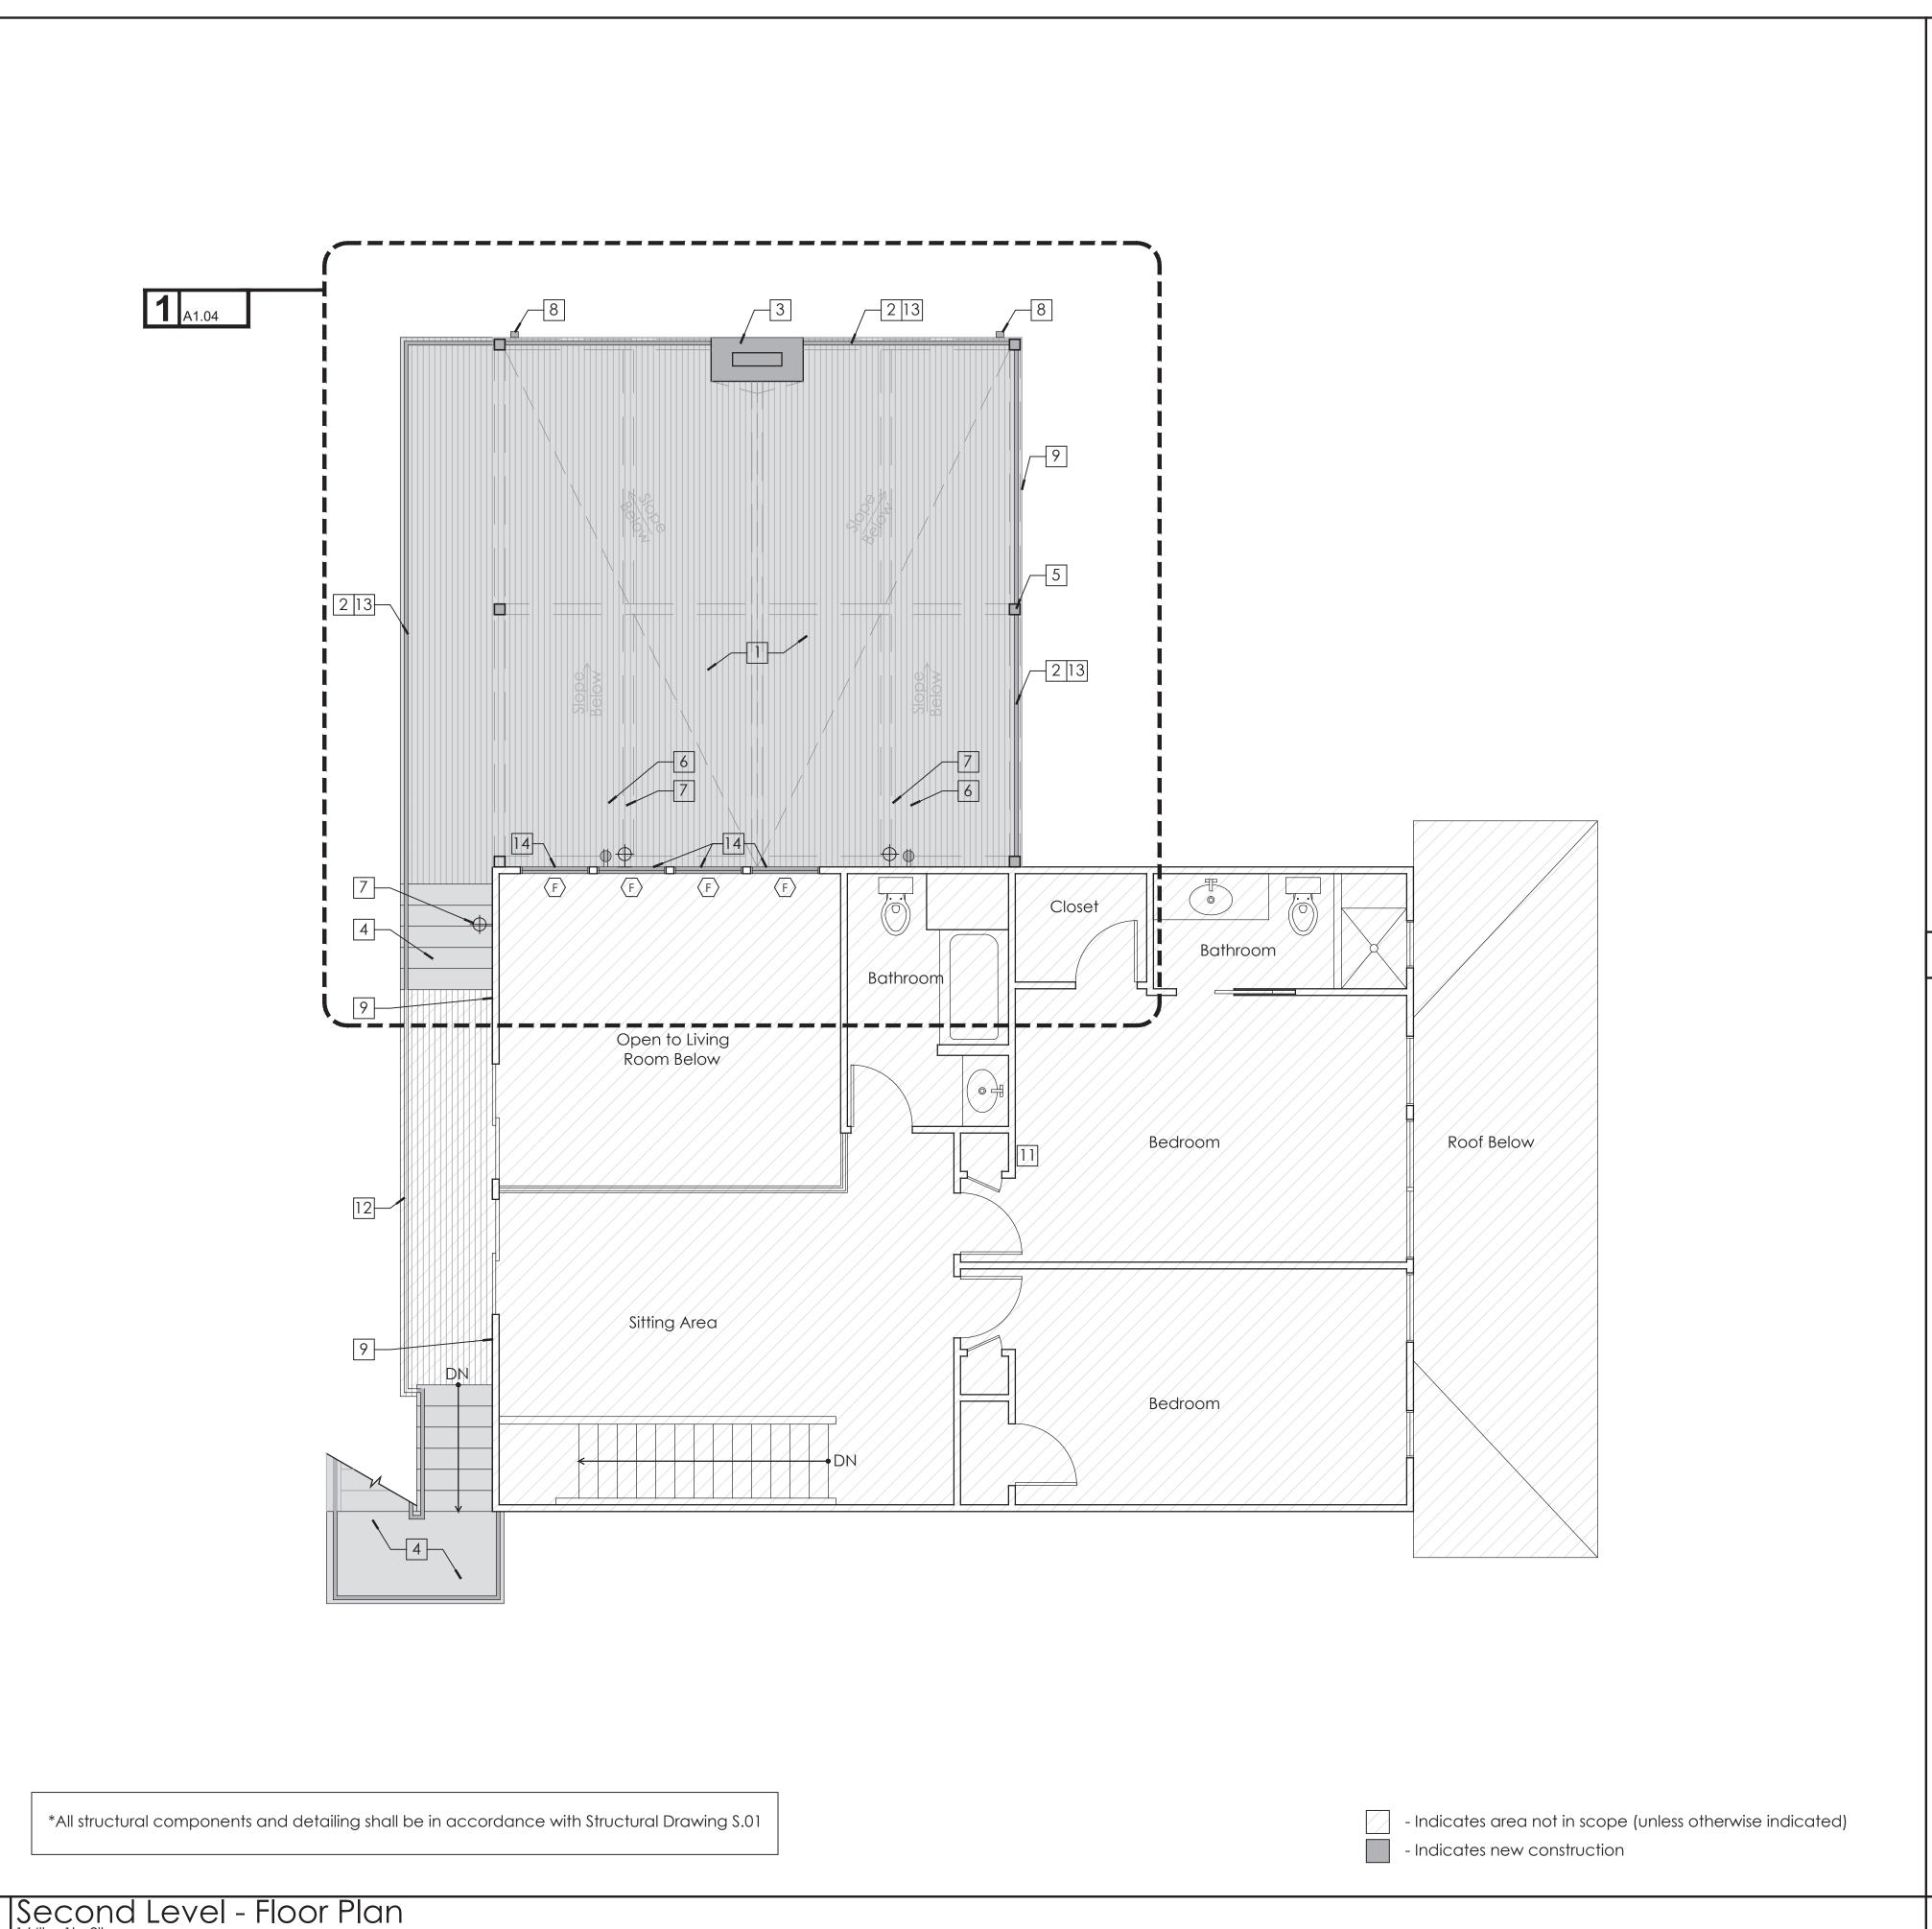

-Required demolition and repair of areas that are necessary to provide the finished work, but not specifically or implicitly indicated in the plans, are the responsibility of the Contractor.

-GC to coordinate all work with home owner to minimize disturbances.

-GC to familiarize him/herself with field conditions prior to commencement of work and notify Architect of any discrepancies or unforeseen conditions prior to commencement of work

-All dimensions throughout to be verified in field. Shop drawings and samples to be provided before fabrication of all millwork pieces.

-All finishes, flooring, doors, windows, trim, wall paneling, and moldings that are existing to remain shall be protected during demolition and construction. Repair as required.

-Existing electrical outlets, switches, phone, and data to remain throughout, unless otherwise indicated. Protect during demolition and construction. When electrical devices are installed in partitions or ceilings to be removed, the electrical contractor shall disconnect them up to the next outlet to remain or back to the panel board. If existing to remain outlets are fed through demolished partitions or ceilings, the circuit shall be rearranged to maintain circuit continuity. Wire shall be removed back to the source from inaccessible raceways not re-used. Install blank plates on flush outlets not re-used. Plate color shall match adjacent surface near as possible in finished areas. Final finish to be consulted with the Architect.

-All existing structural elements to remain and be protected during demolition and construction.

-Any discrepancy between Architectural drawings and Consultant drawings (i.e. Interiors etc.) is to be immediately brought to the attention of the Architect in writing prior to the continuation of work.

-Provide blocking at all wall mounted accessories, fixtures, etc.

-Where existing wall or floor mounted elements are removed, patch disturbed surfaces to match existing adjacent and prepare to receive new finishes as scheduled.

-All new floor finishes to be installed under cabinetry and millwork, typical.

-All existing conditions in these plans are based on As-Built Floor Plans by MacNelly-Cohen Architects. Existing conditions and dimensions should be verified by contractor for accuracy and any discrepancies shall be reported to the Architect in writing prior to commencement of work.

## and basement Addition

Master Bedroom Suite and Basement Addition

Hirsh Residence

12 Brook Hollow Road West Tisbury, MA 02575



González Architects Residential

#### General Notes

#### Notes:

- New roof deck over built up flat roof. New roof deck, wood width and orientation to match existing deck. See details.
- New roof deck to have new horizontal metal wire railing system. Gaps between wires shall be less then 4" typical.
- 3 New chimney. See detail.
- New deck stairs connecting the existing stairs to the second level deck and new roof deck. New stair to be consistent with existing stair.
- Wood posts to support roof trellis structure.
- 6 New exterior wall outlet on roof deck.
- 7 New wall mounted lighting on roof deck.
- Leader and down spout for roof drainage.
- New cedar shingles on addtion to match existing house.
- Glass railing facing to water
- 11 Add power to existing thermostat locations.
- All deck railings to be replaced with horizontal metal wire railing system. Gaps between wires shall be less then 4" typical.
- 13 Add electrical wiring for down lighting within new railing system.
- 14 New transom windows in upper Living Room.





Registration Seal Address 14 NE First Avenue STE 500 Miami FL 33132 T +1 (305) 455 4216

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No Date Description

Drawing No.

Second Level

Scale As Noted

Date September 23, 2021


Drawn By RW

Project No. 17xxx

A1.03

Floor Plan

Notes

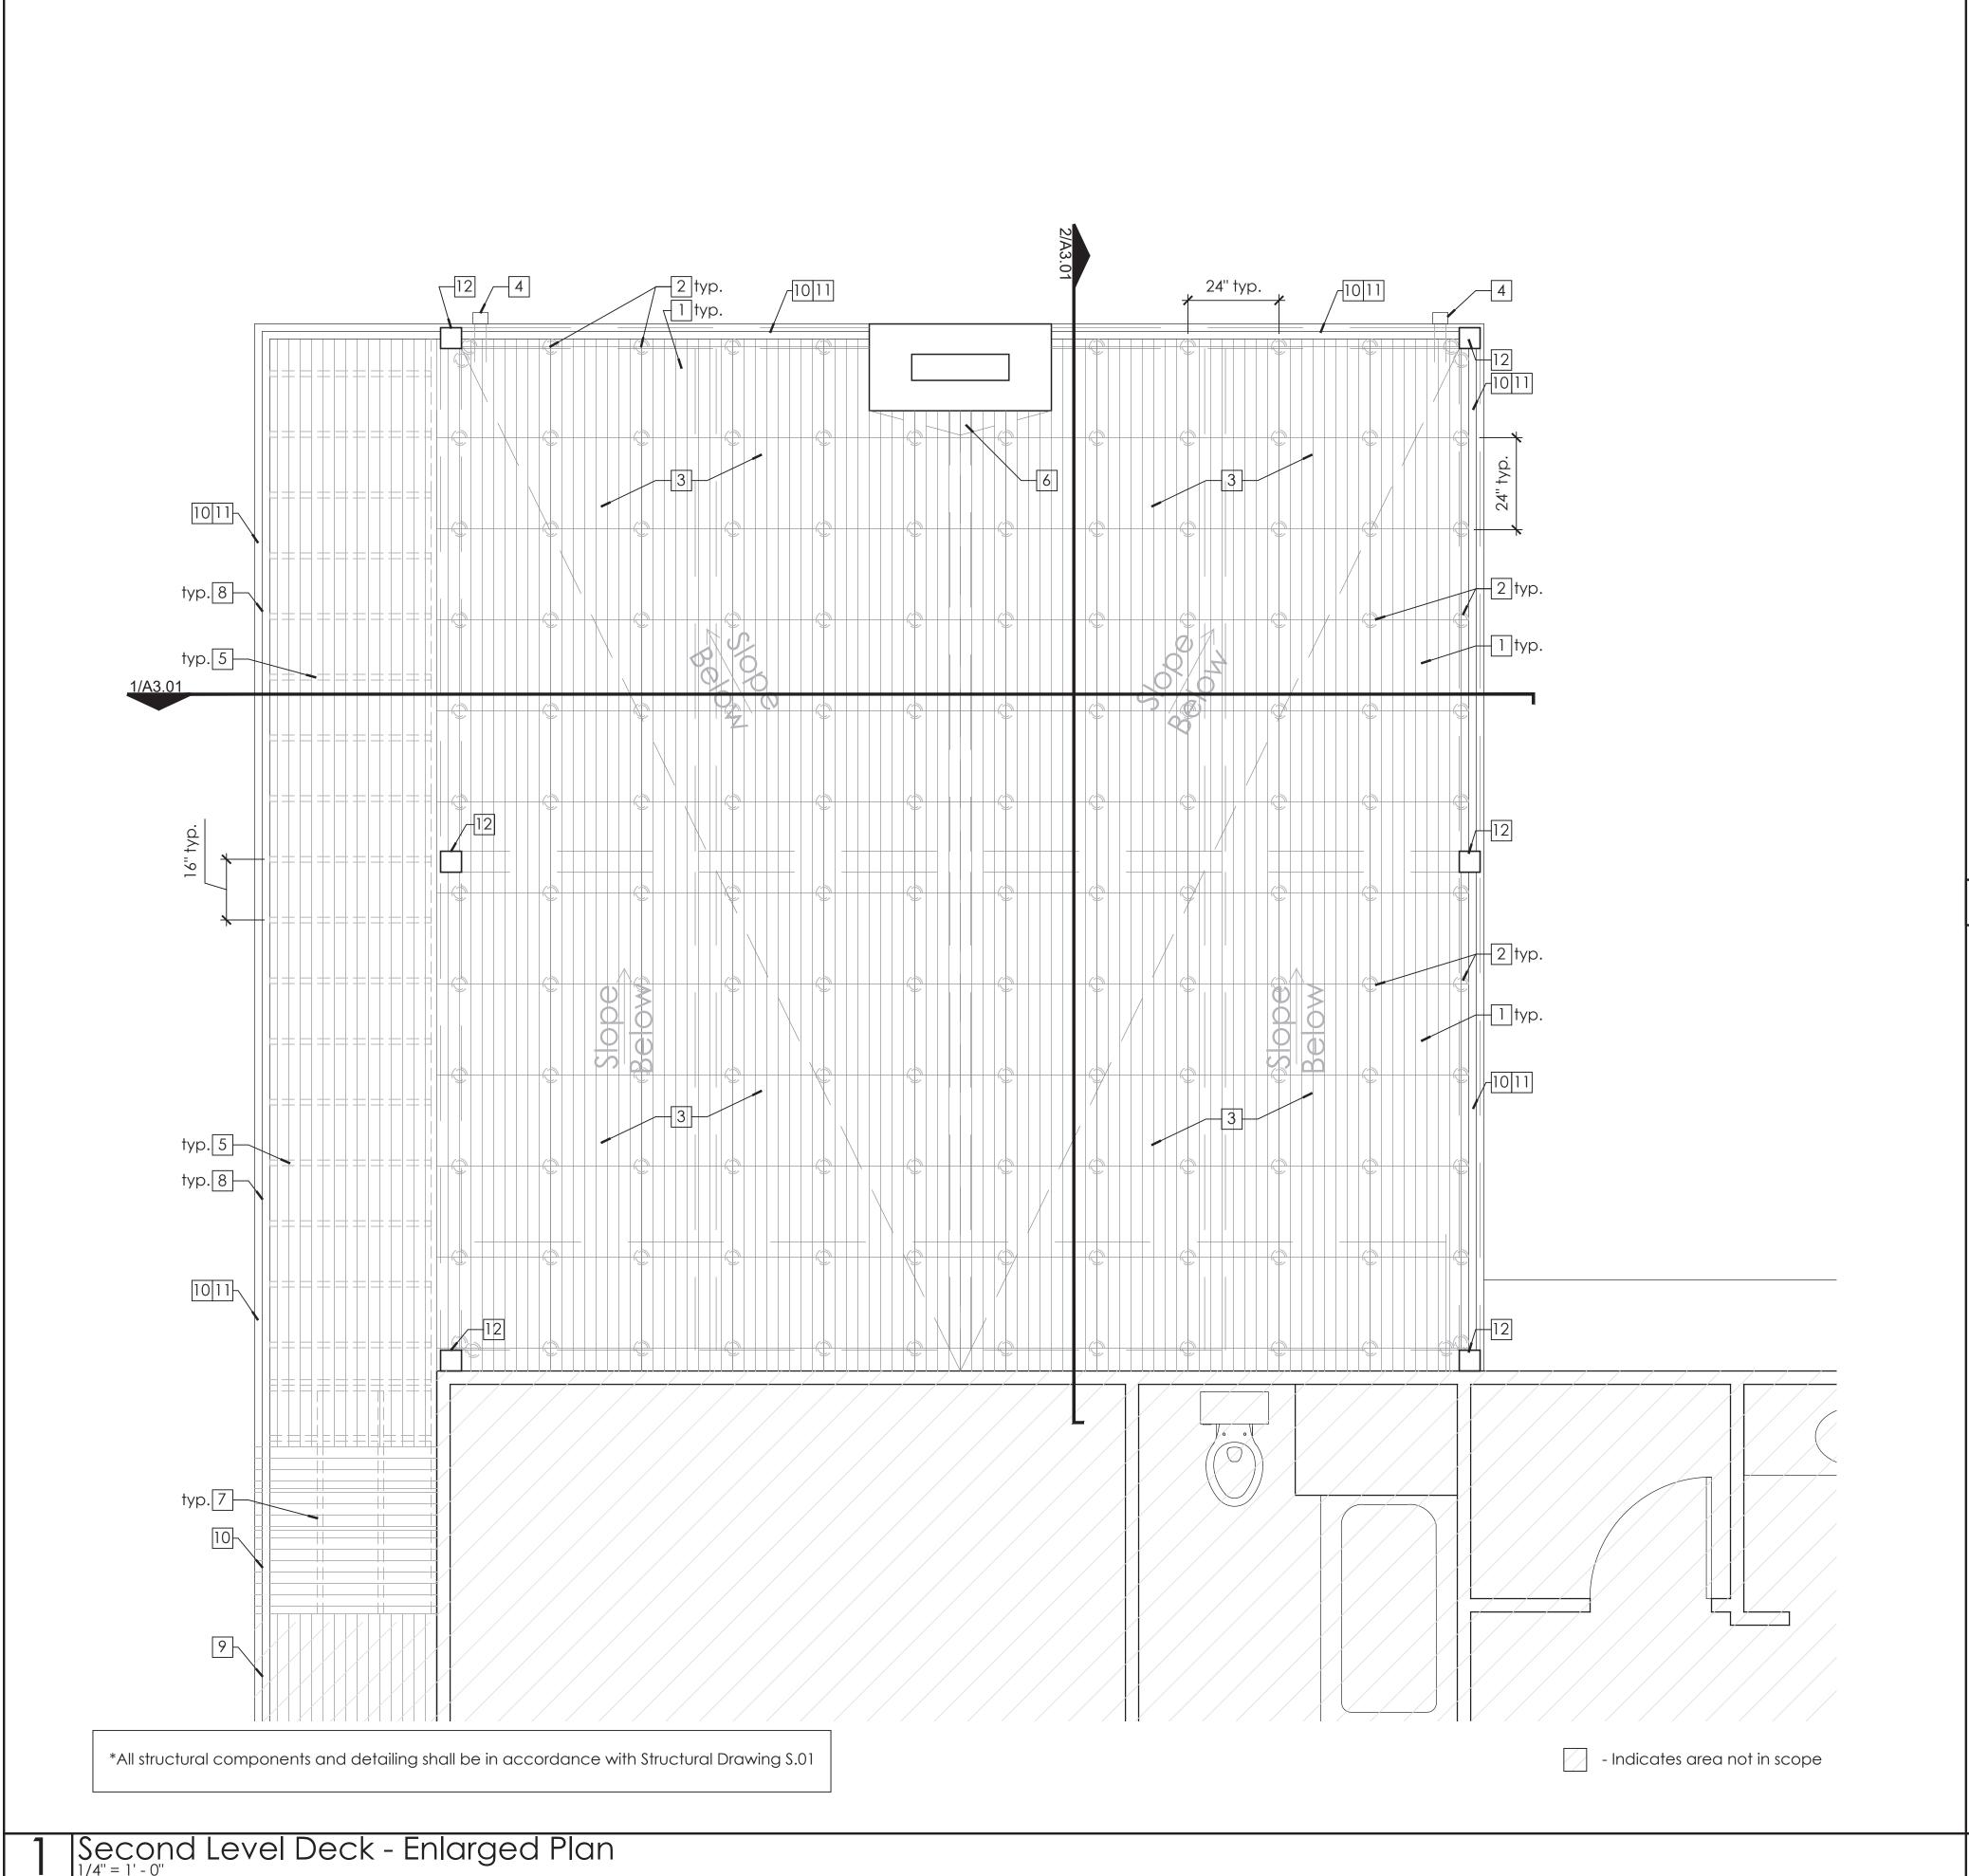

-Required demolition and repair of areas that are necessary to provide the finished work, but not specifically or implicitly indicated in the plans, are the responsibility of the Contractor.

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-All finishes, flooring, doors, windows, trim, wall paneling, and moldings that are existing to remain shall be protected during demolition and construction. Repair as required.

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#### Hirsh Residence

Master Bedroom Suite and Basement Addition

12 Brook Hollow Road West Tisbury, MA 02575



González Architects Residential

#### General Notes

#### Notes:

- 24" x 24" Bison Wood Roof Deck Tiles to match existing deck species and finish on Pedestal System.
- 2 Level It Adjustable Pedestal System by Bison spaced @ 24" O.C. Refer to manufacture's installation instructions.
- Built up roof deck on tapered rigid foam insulation (min. thickness  $1\frac{1}{2}$ ") @  $\frac{1}{4}$ " per foot slope min. on  $\frac{3}{4}$ " plywood sheathing.
- Leader and down spout for roof drainage.
- Wood deck to match existing decking size, species and finish over 2x6 P.T. deck joists @ 16" O.C. See sections.
- Cricket to be provided at chimney for drainage.
- New stair treads and risers (to match existing deck species and finish) over new P.T. 2x carriages.
- 8 P.T. (2) 2x12 deck beam.
- All deck railings to be replaced with horizontal metal wire railing system. Gaps between wires shall be less then 4" typical.
- New roof deck to have new horizontal metal wire railing system. Gaps between wires shall be less then 4" typical.
- Add electrical wiring for down lighting within new railing system.
- Wood posts to support roof trellis structure.





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No Date Description

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Drawing Title

Second Level Deck Enlarged Plan

Scale As Noted


Date September 23, 2021

Drawn By RW

Project No. 17xxx

A1.03a

Notes

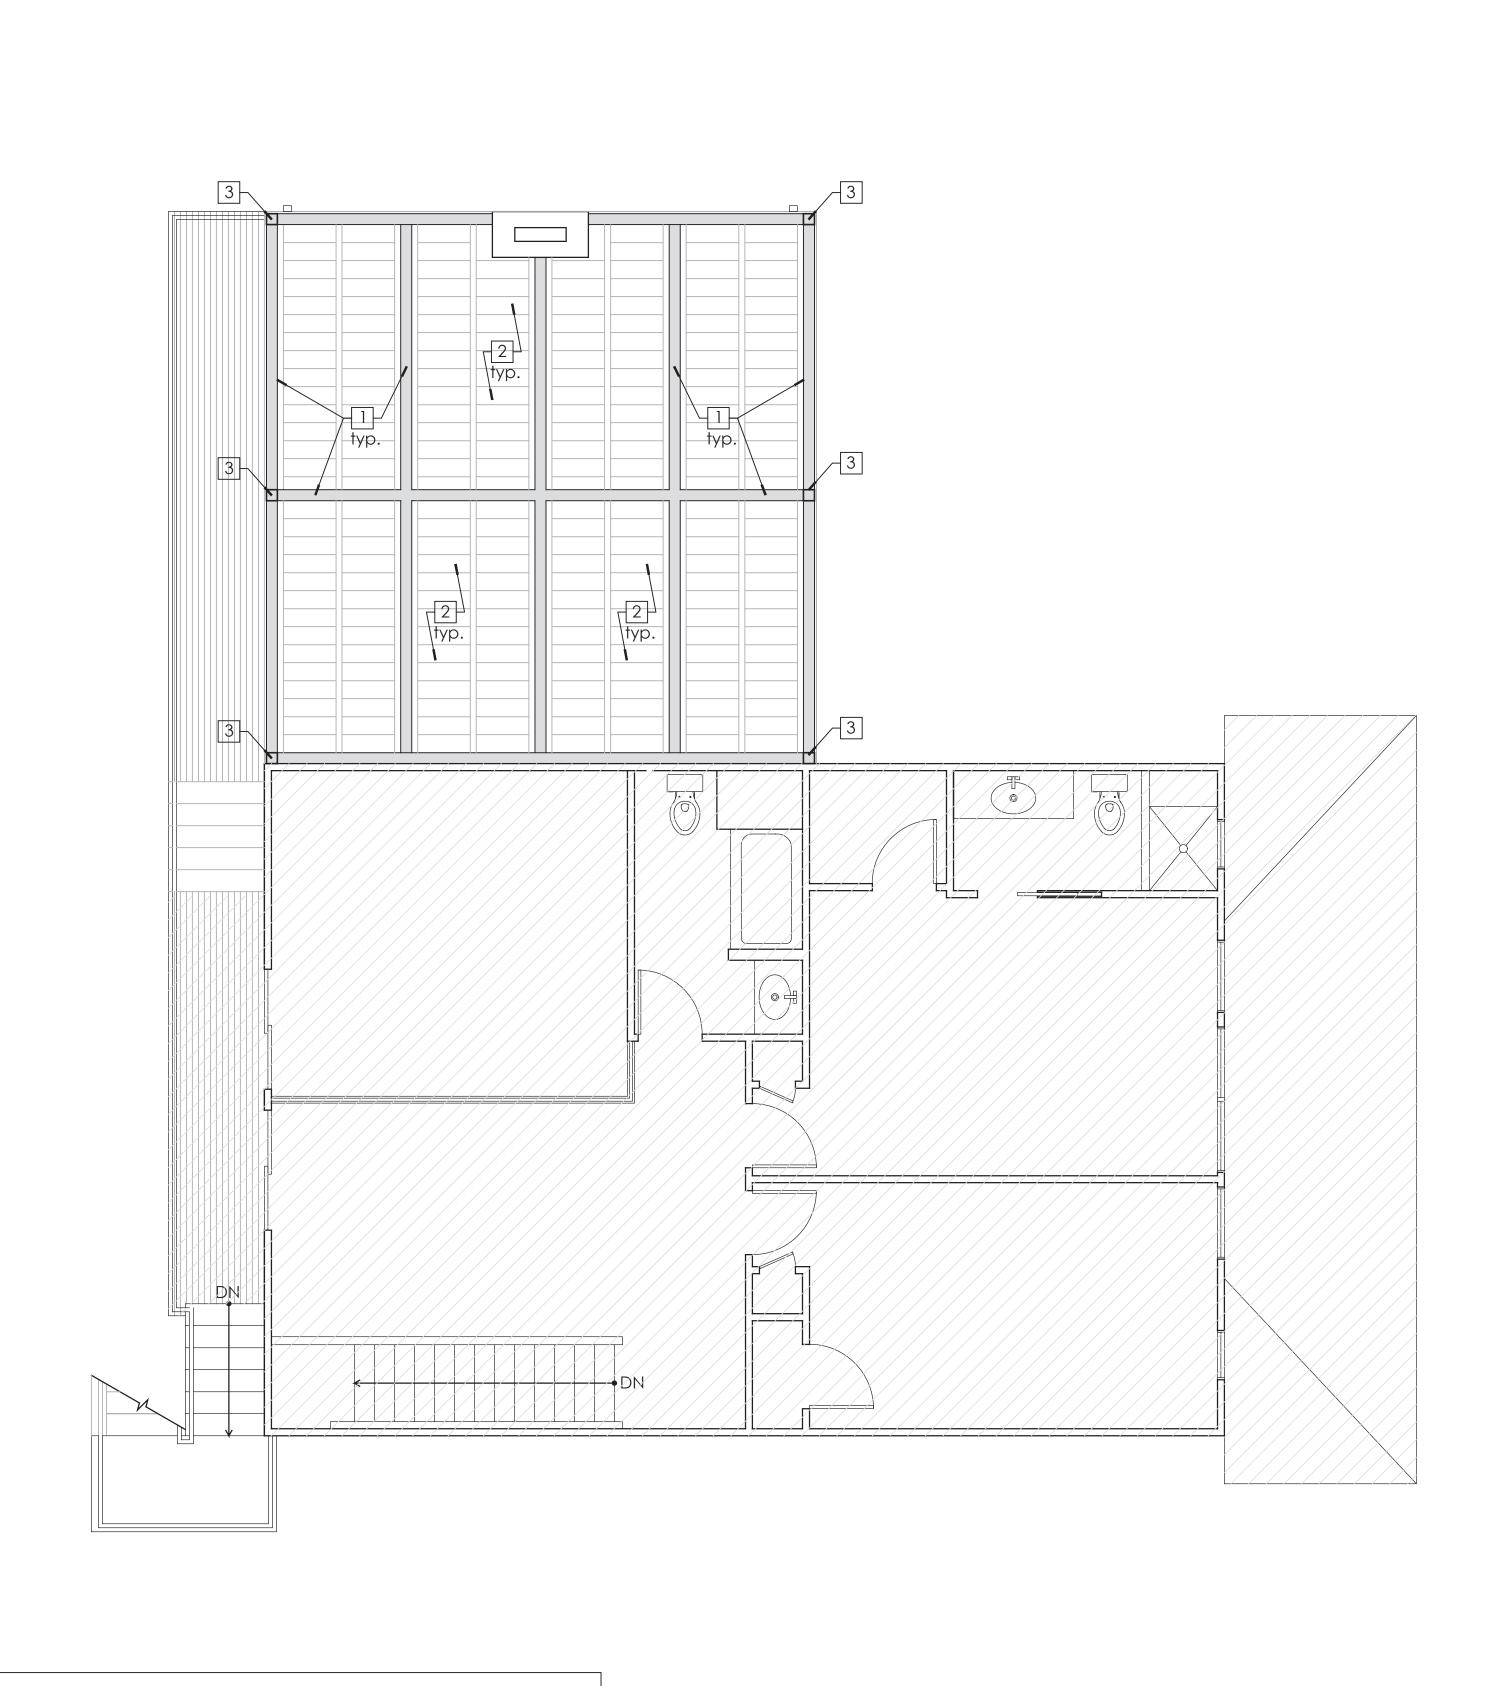

-Required demolition and repair of areas that are necessary to provide the finished work, but not specifically or implicitly indicated in the plans, are the responsibility of the Contractor.

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# General Notes

#### Notes:

1 4" x 12" Wood beam

2 Metal cable with retractable canvas

3 Wood posts to support roof trellis structure.





Hirsh Residence

Master Bedroom Suite

and Basement Addition

12 Brook Hollow Road

West Tisbury, MA 02575

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No Date Descripti
09-23-2021 Permit Se

Drawing Title

Roof Plan

Scale As Noted

Date September 23, 2021

Drawn By RW

Project No. 17xxx


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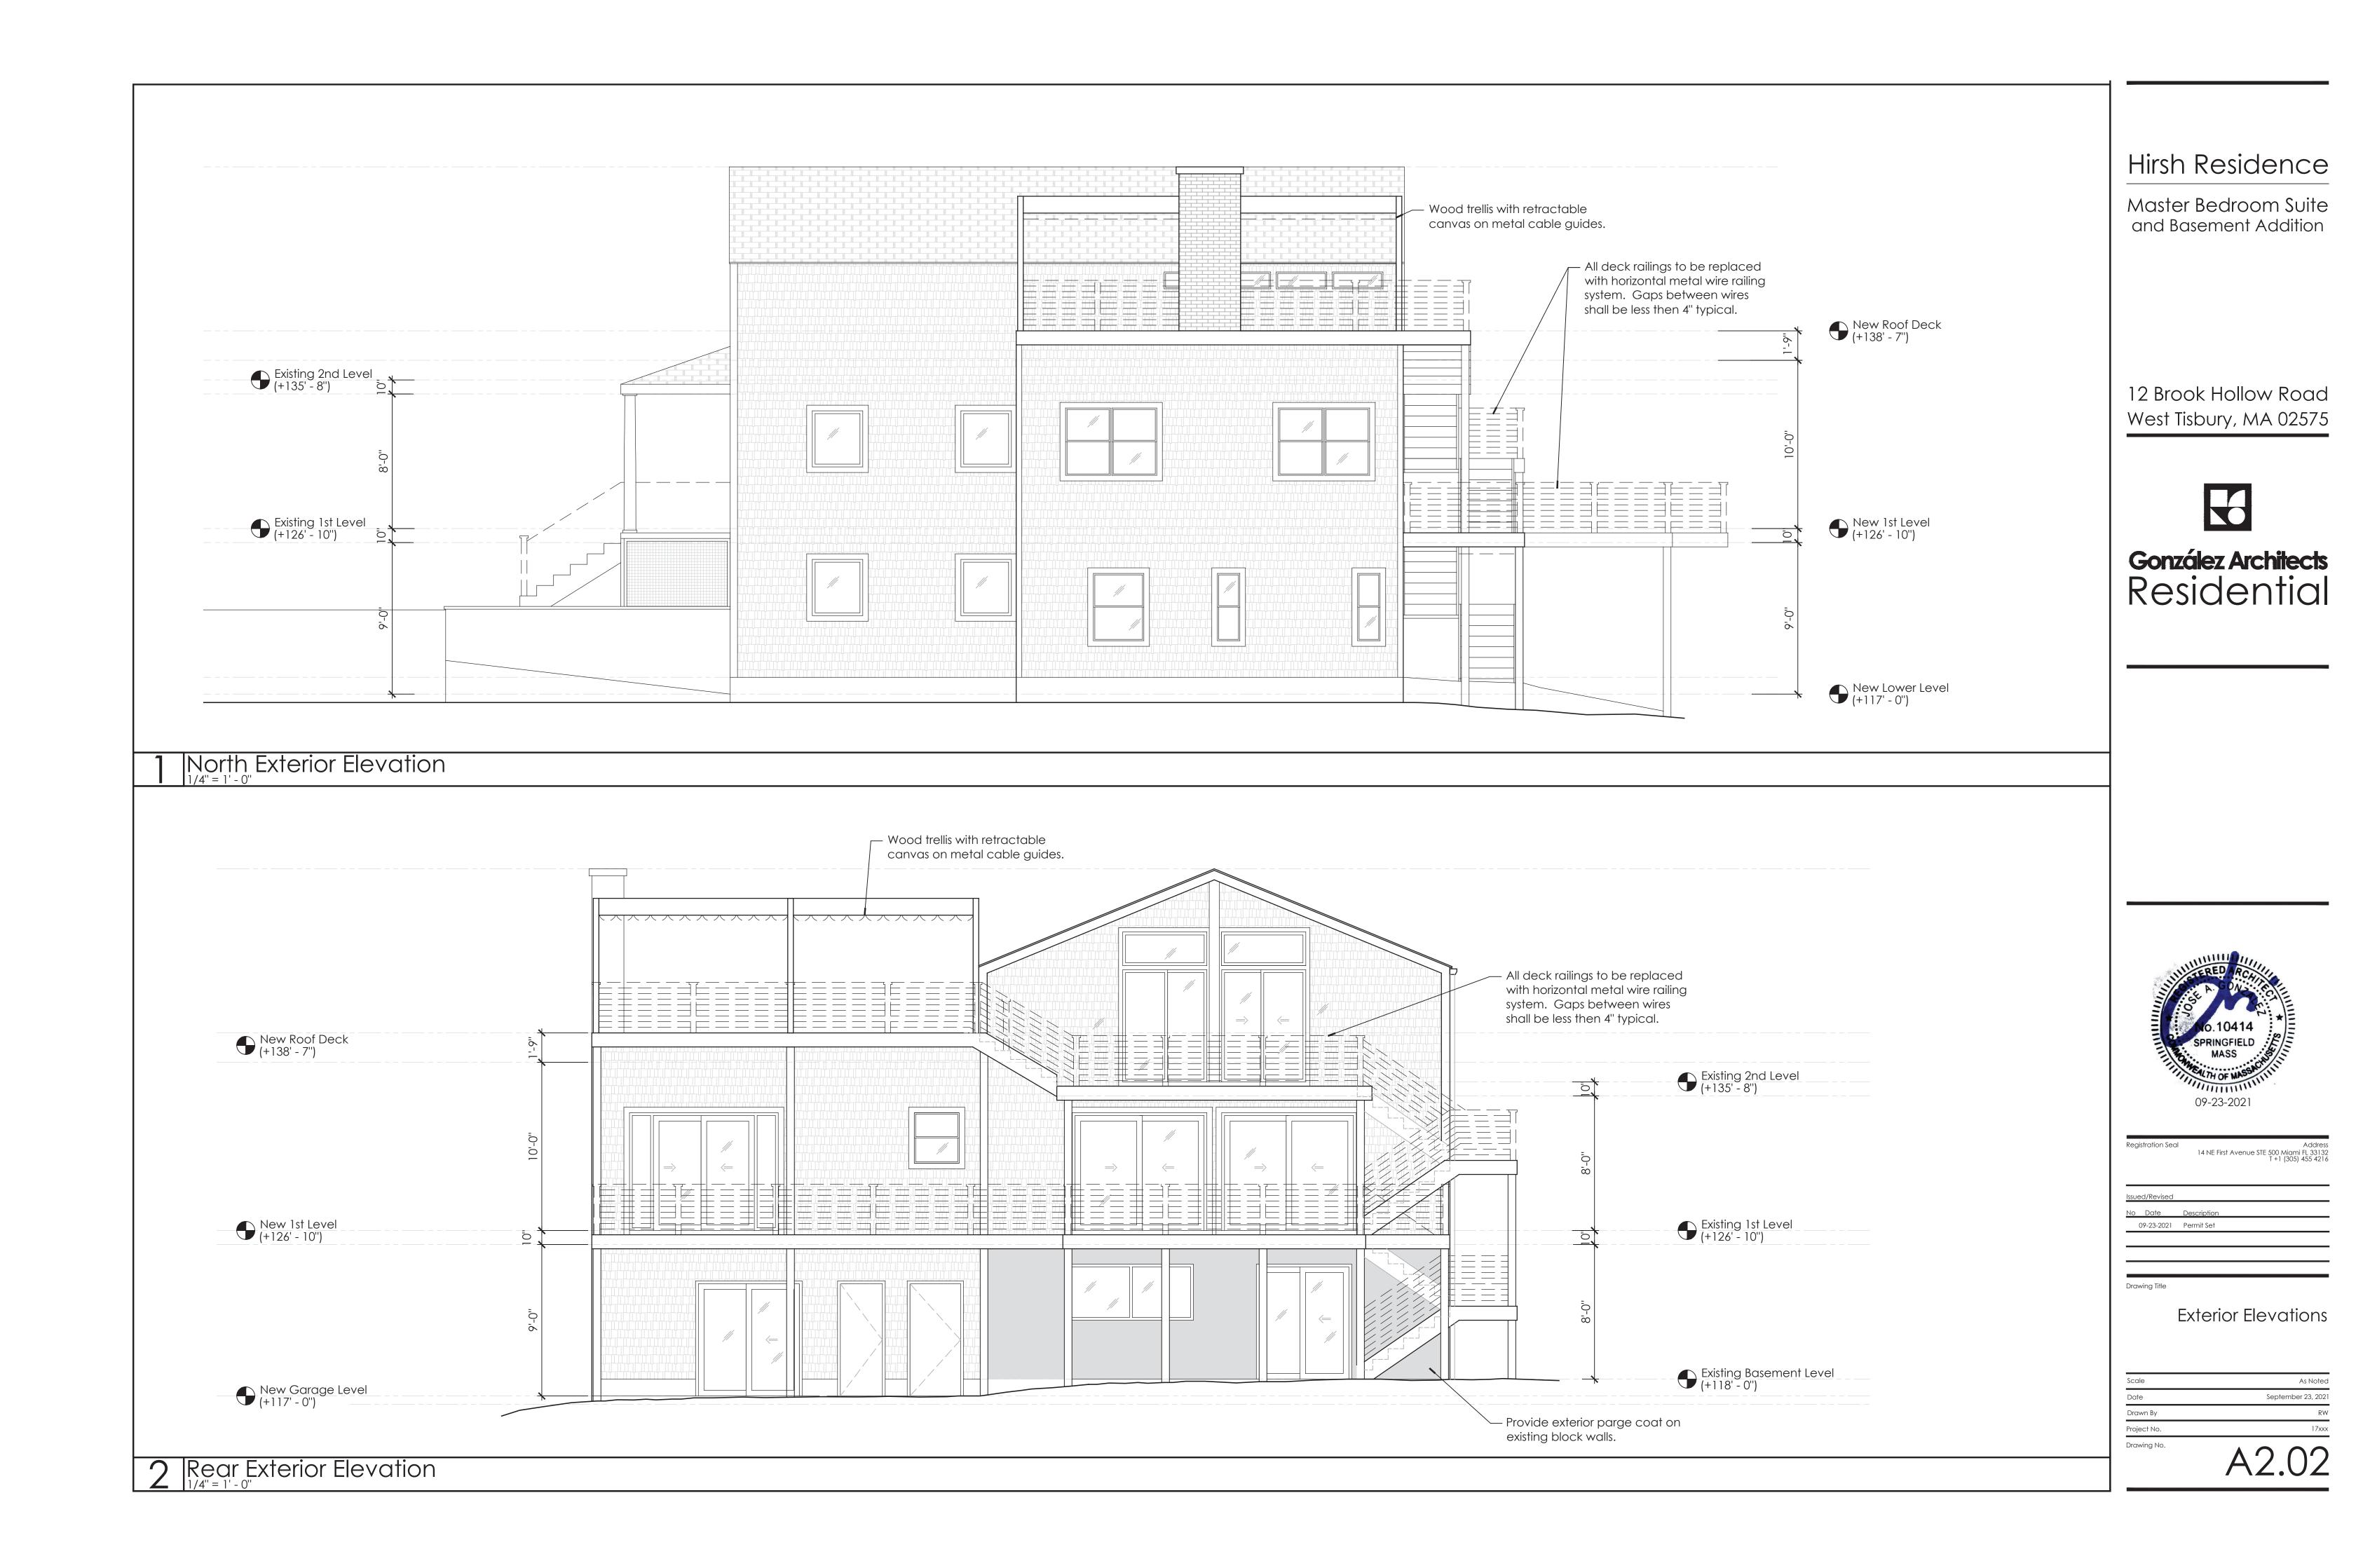
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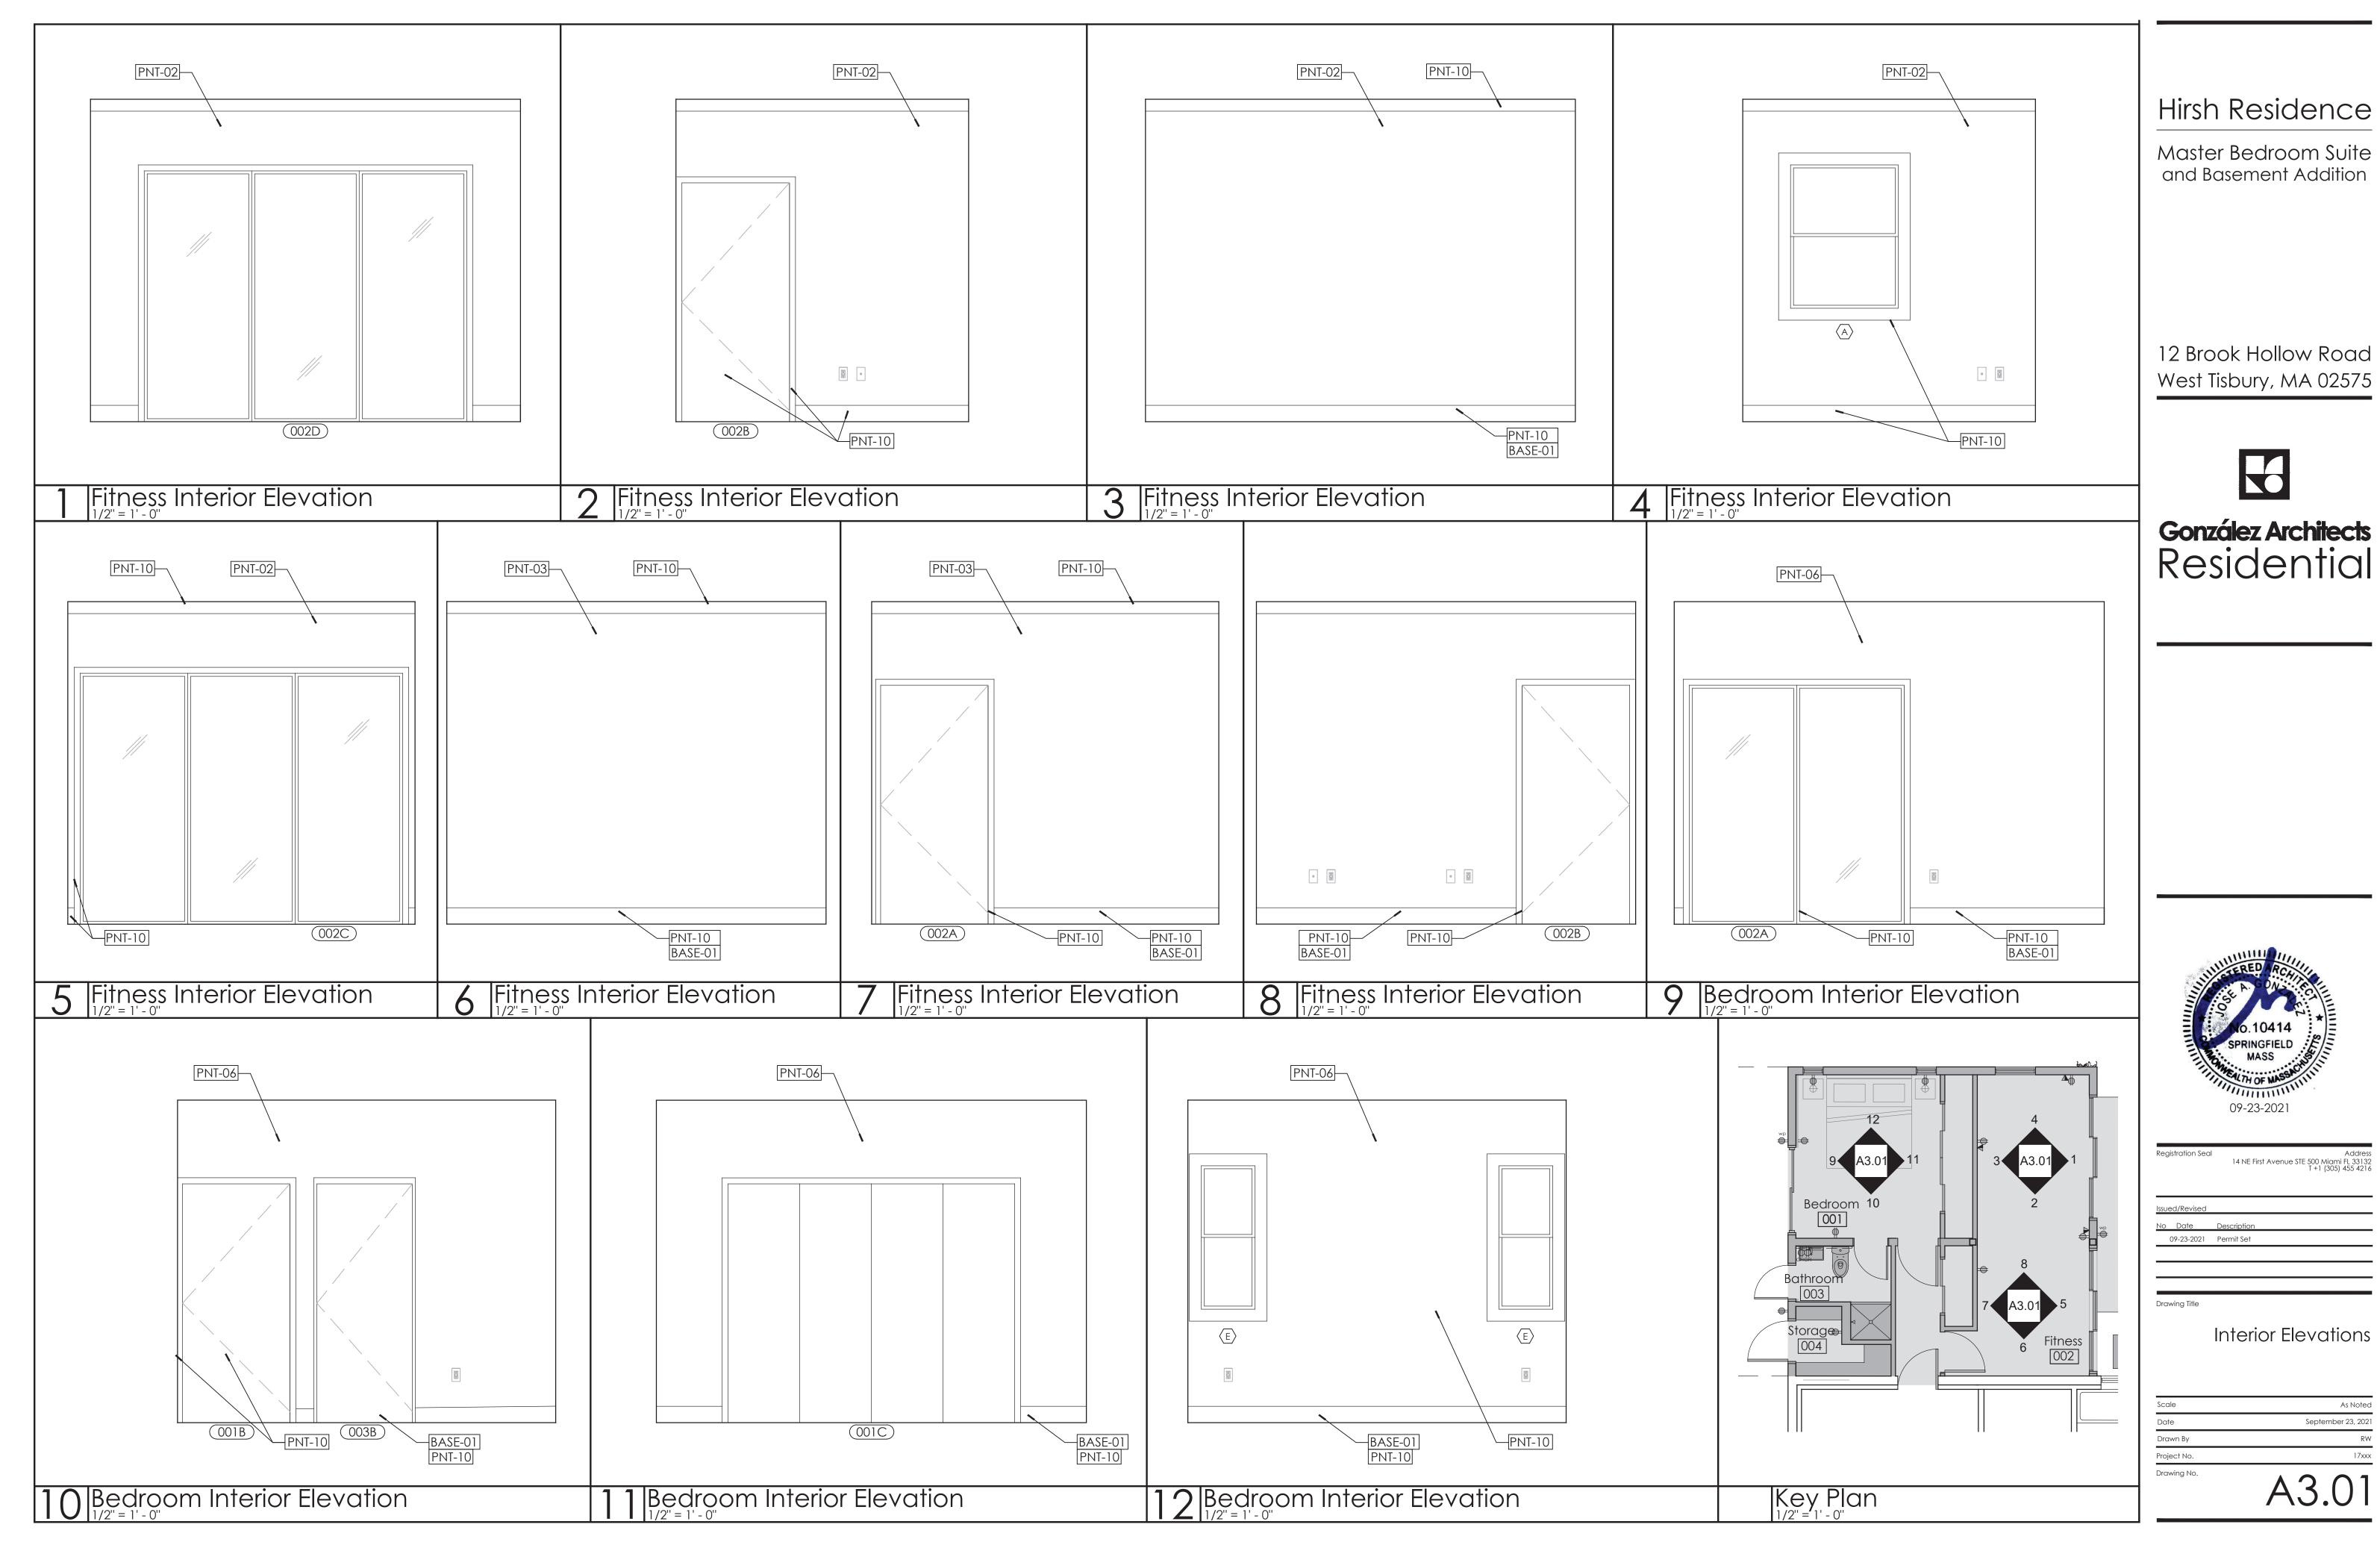
- Indicates area not in scope

Second Level Deck - Enlarged Plan

\*All structural components and detailing shall be in accordance with Structural Drawing S.01






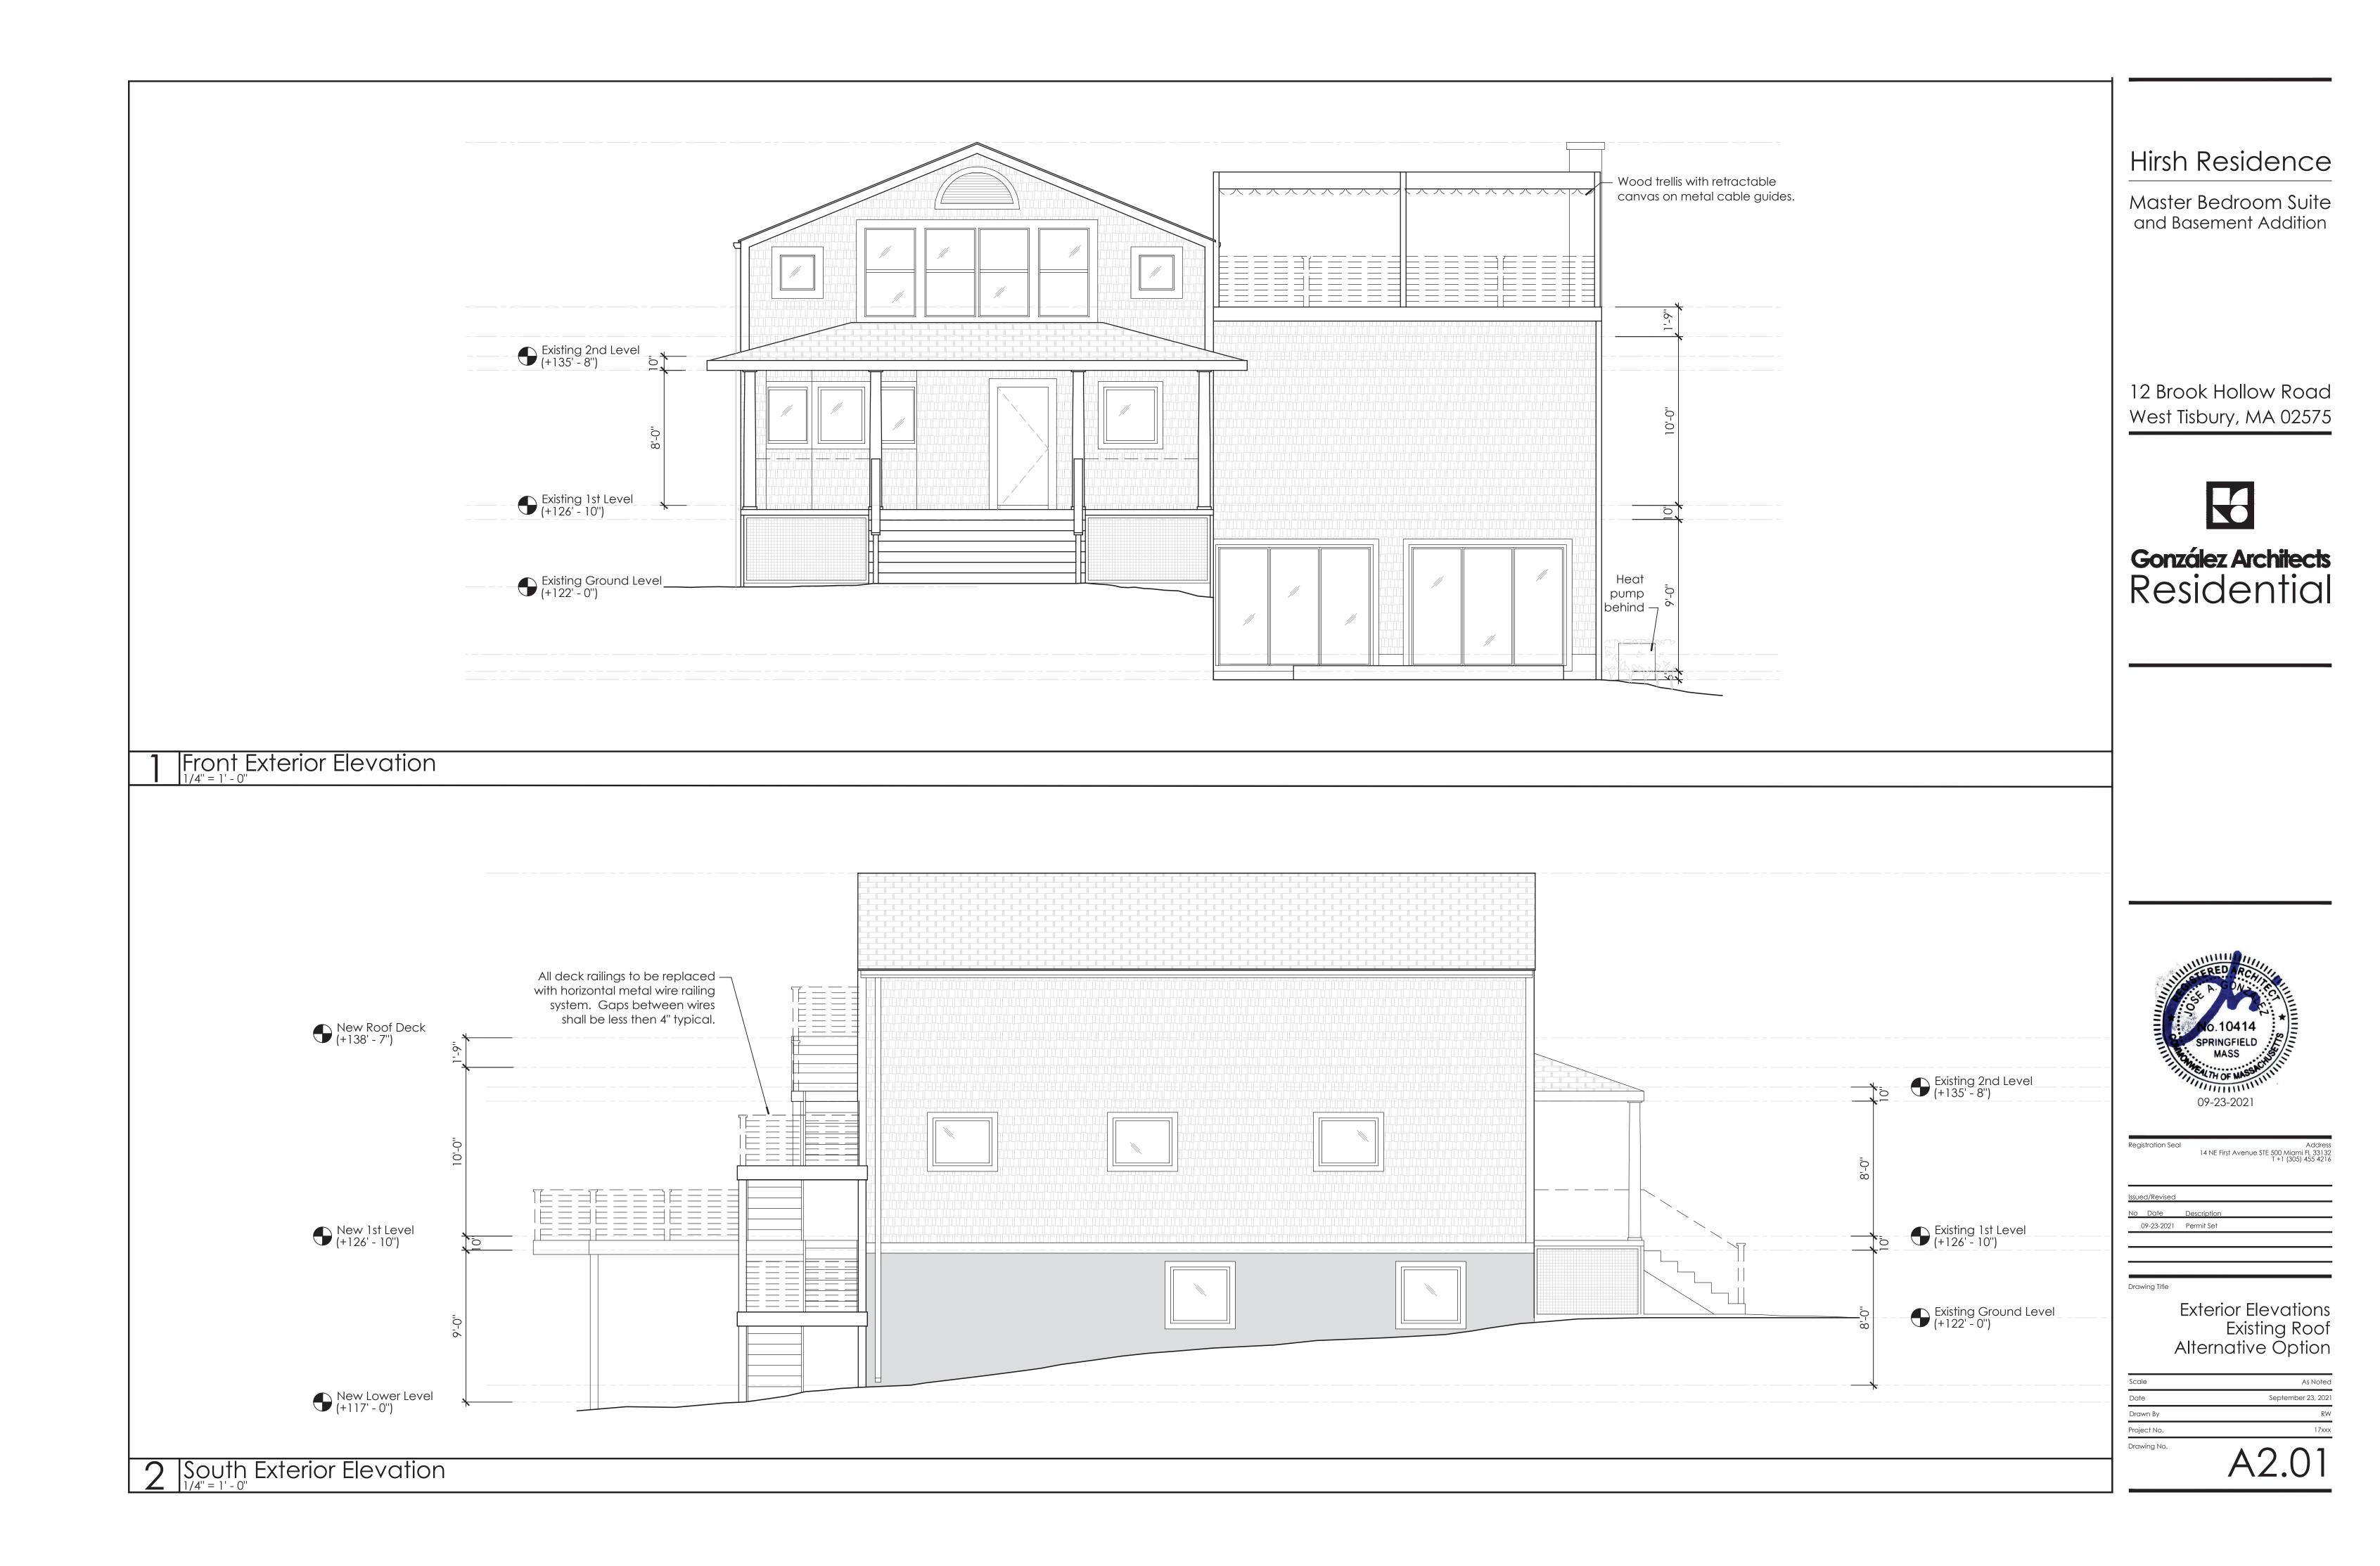



# González Architects

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No	Date	Description
	09-23-2021	Permit Set

Drawing No.	$\wedge$ 2 $\cap$ 1
Project No.	17xxx
Drawn By	RW
Date	September 23, 202
Scale	As Noted

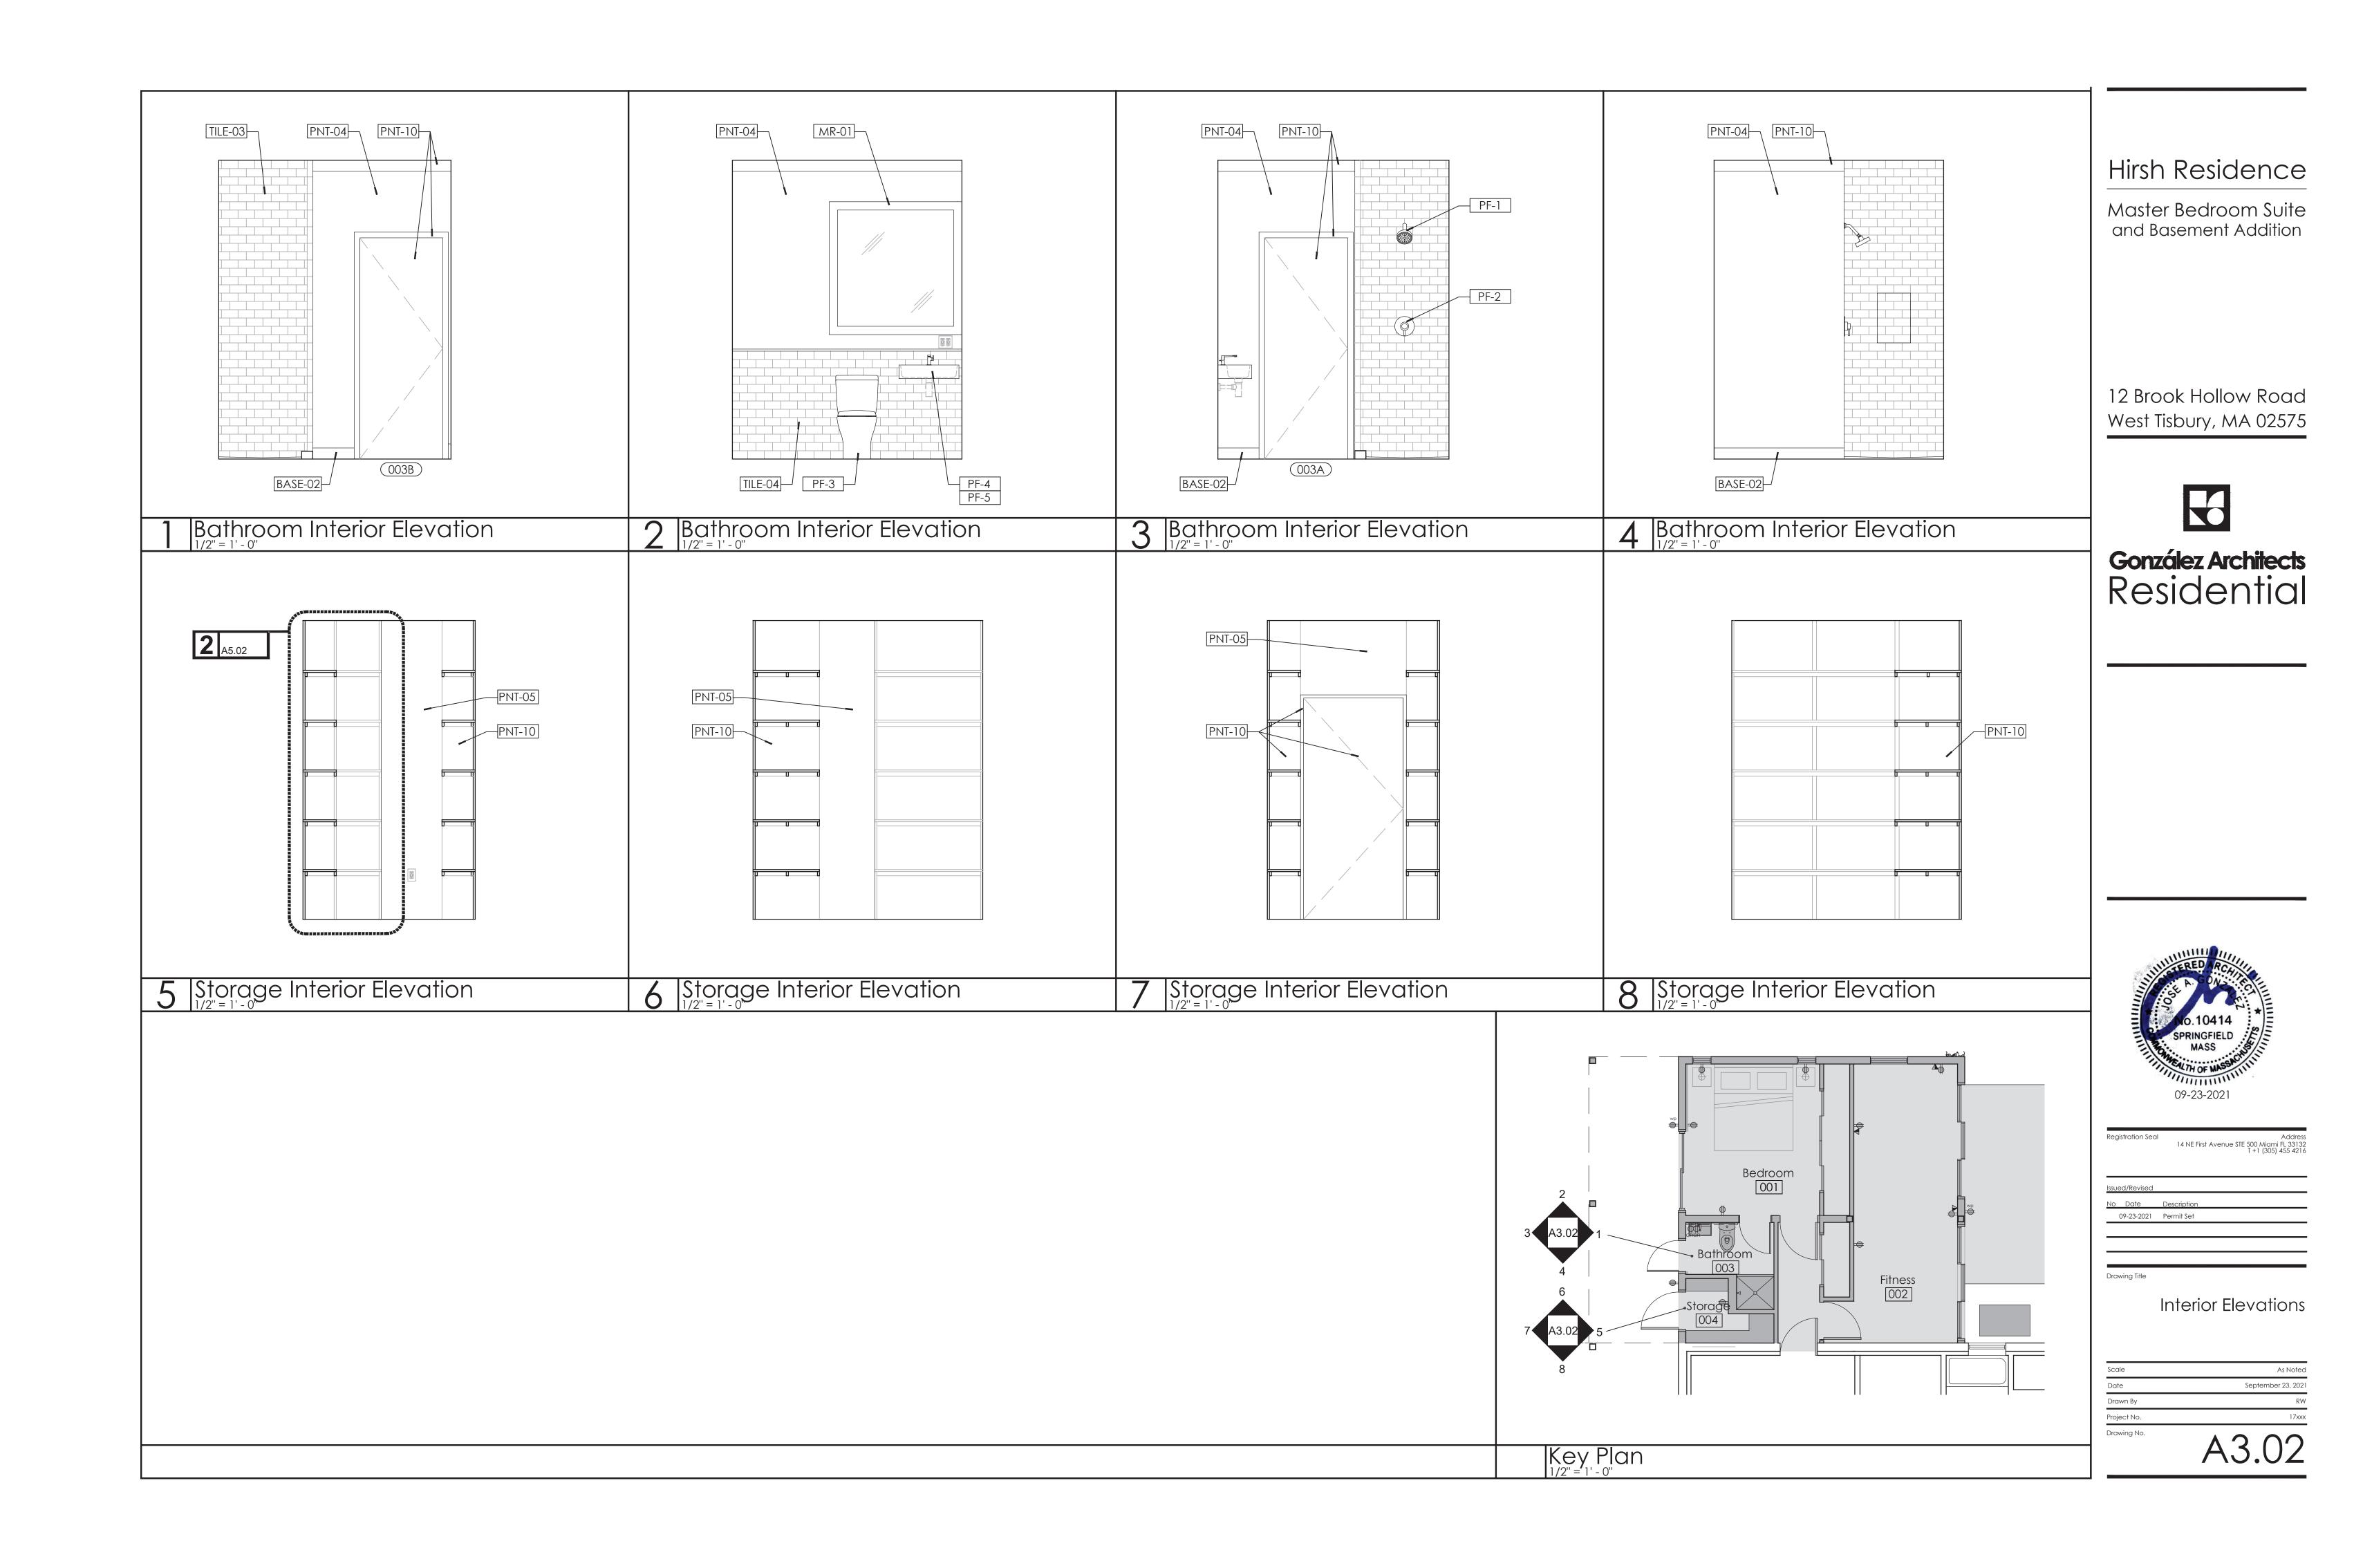


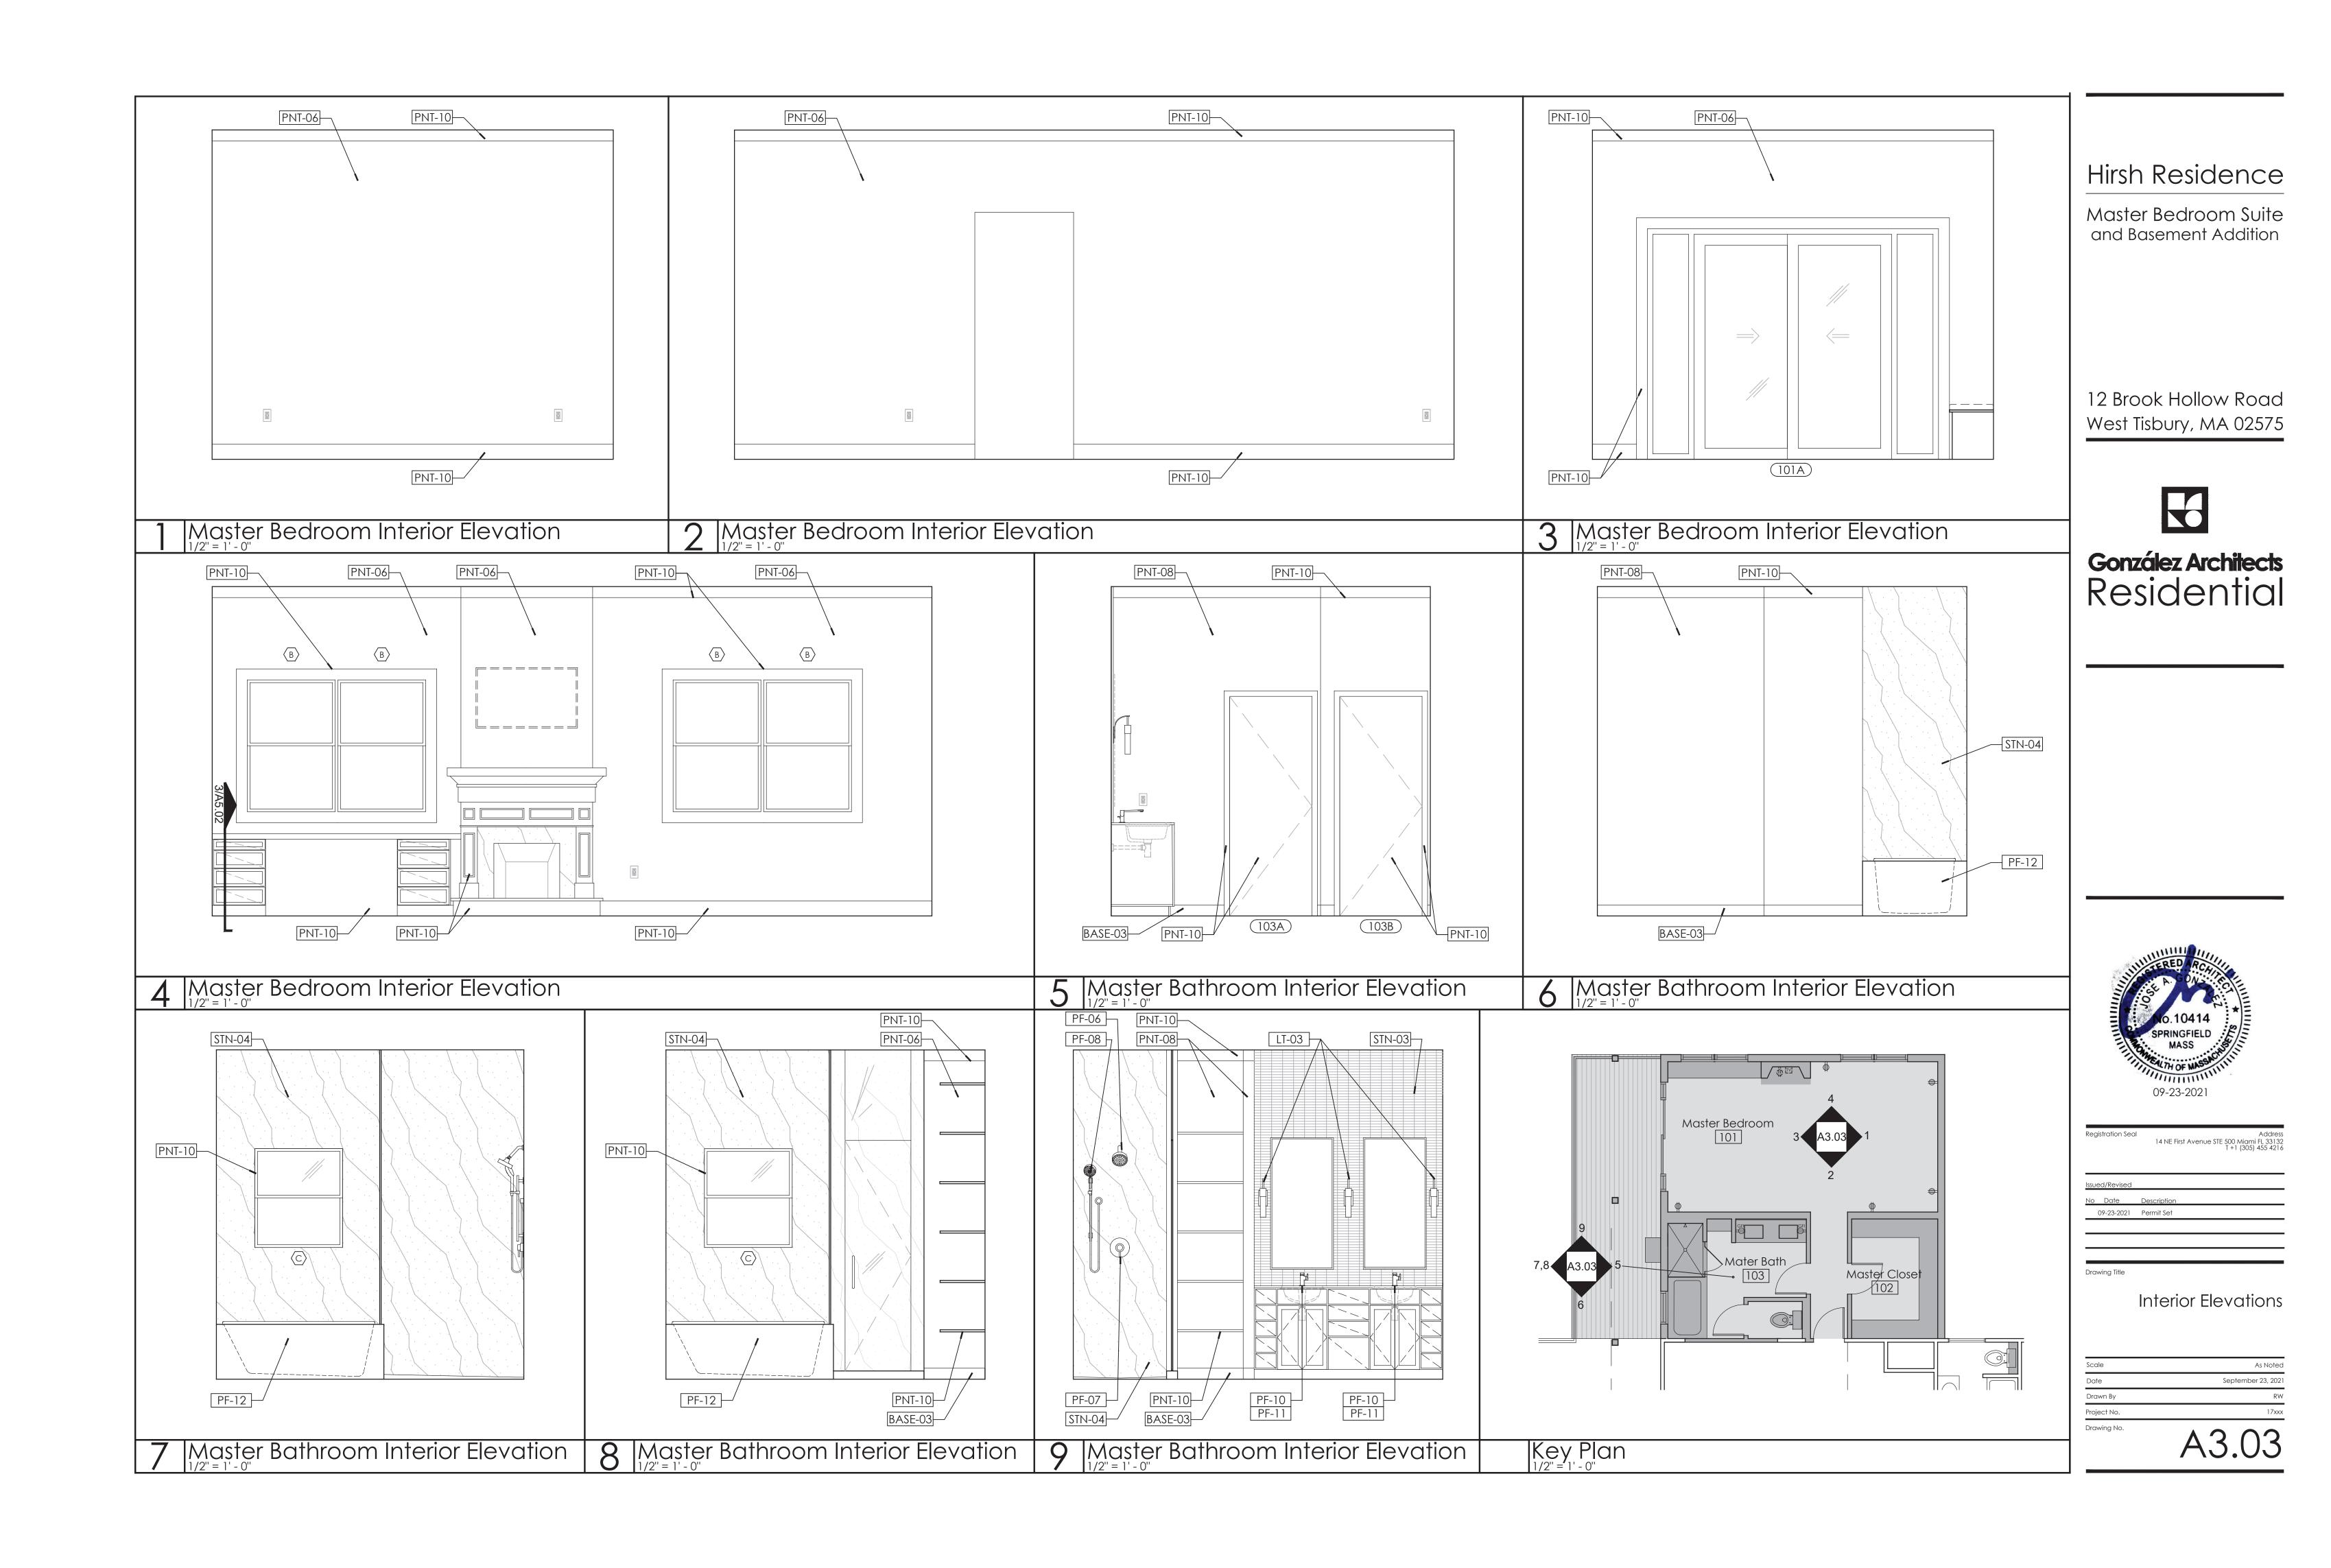


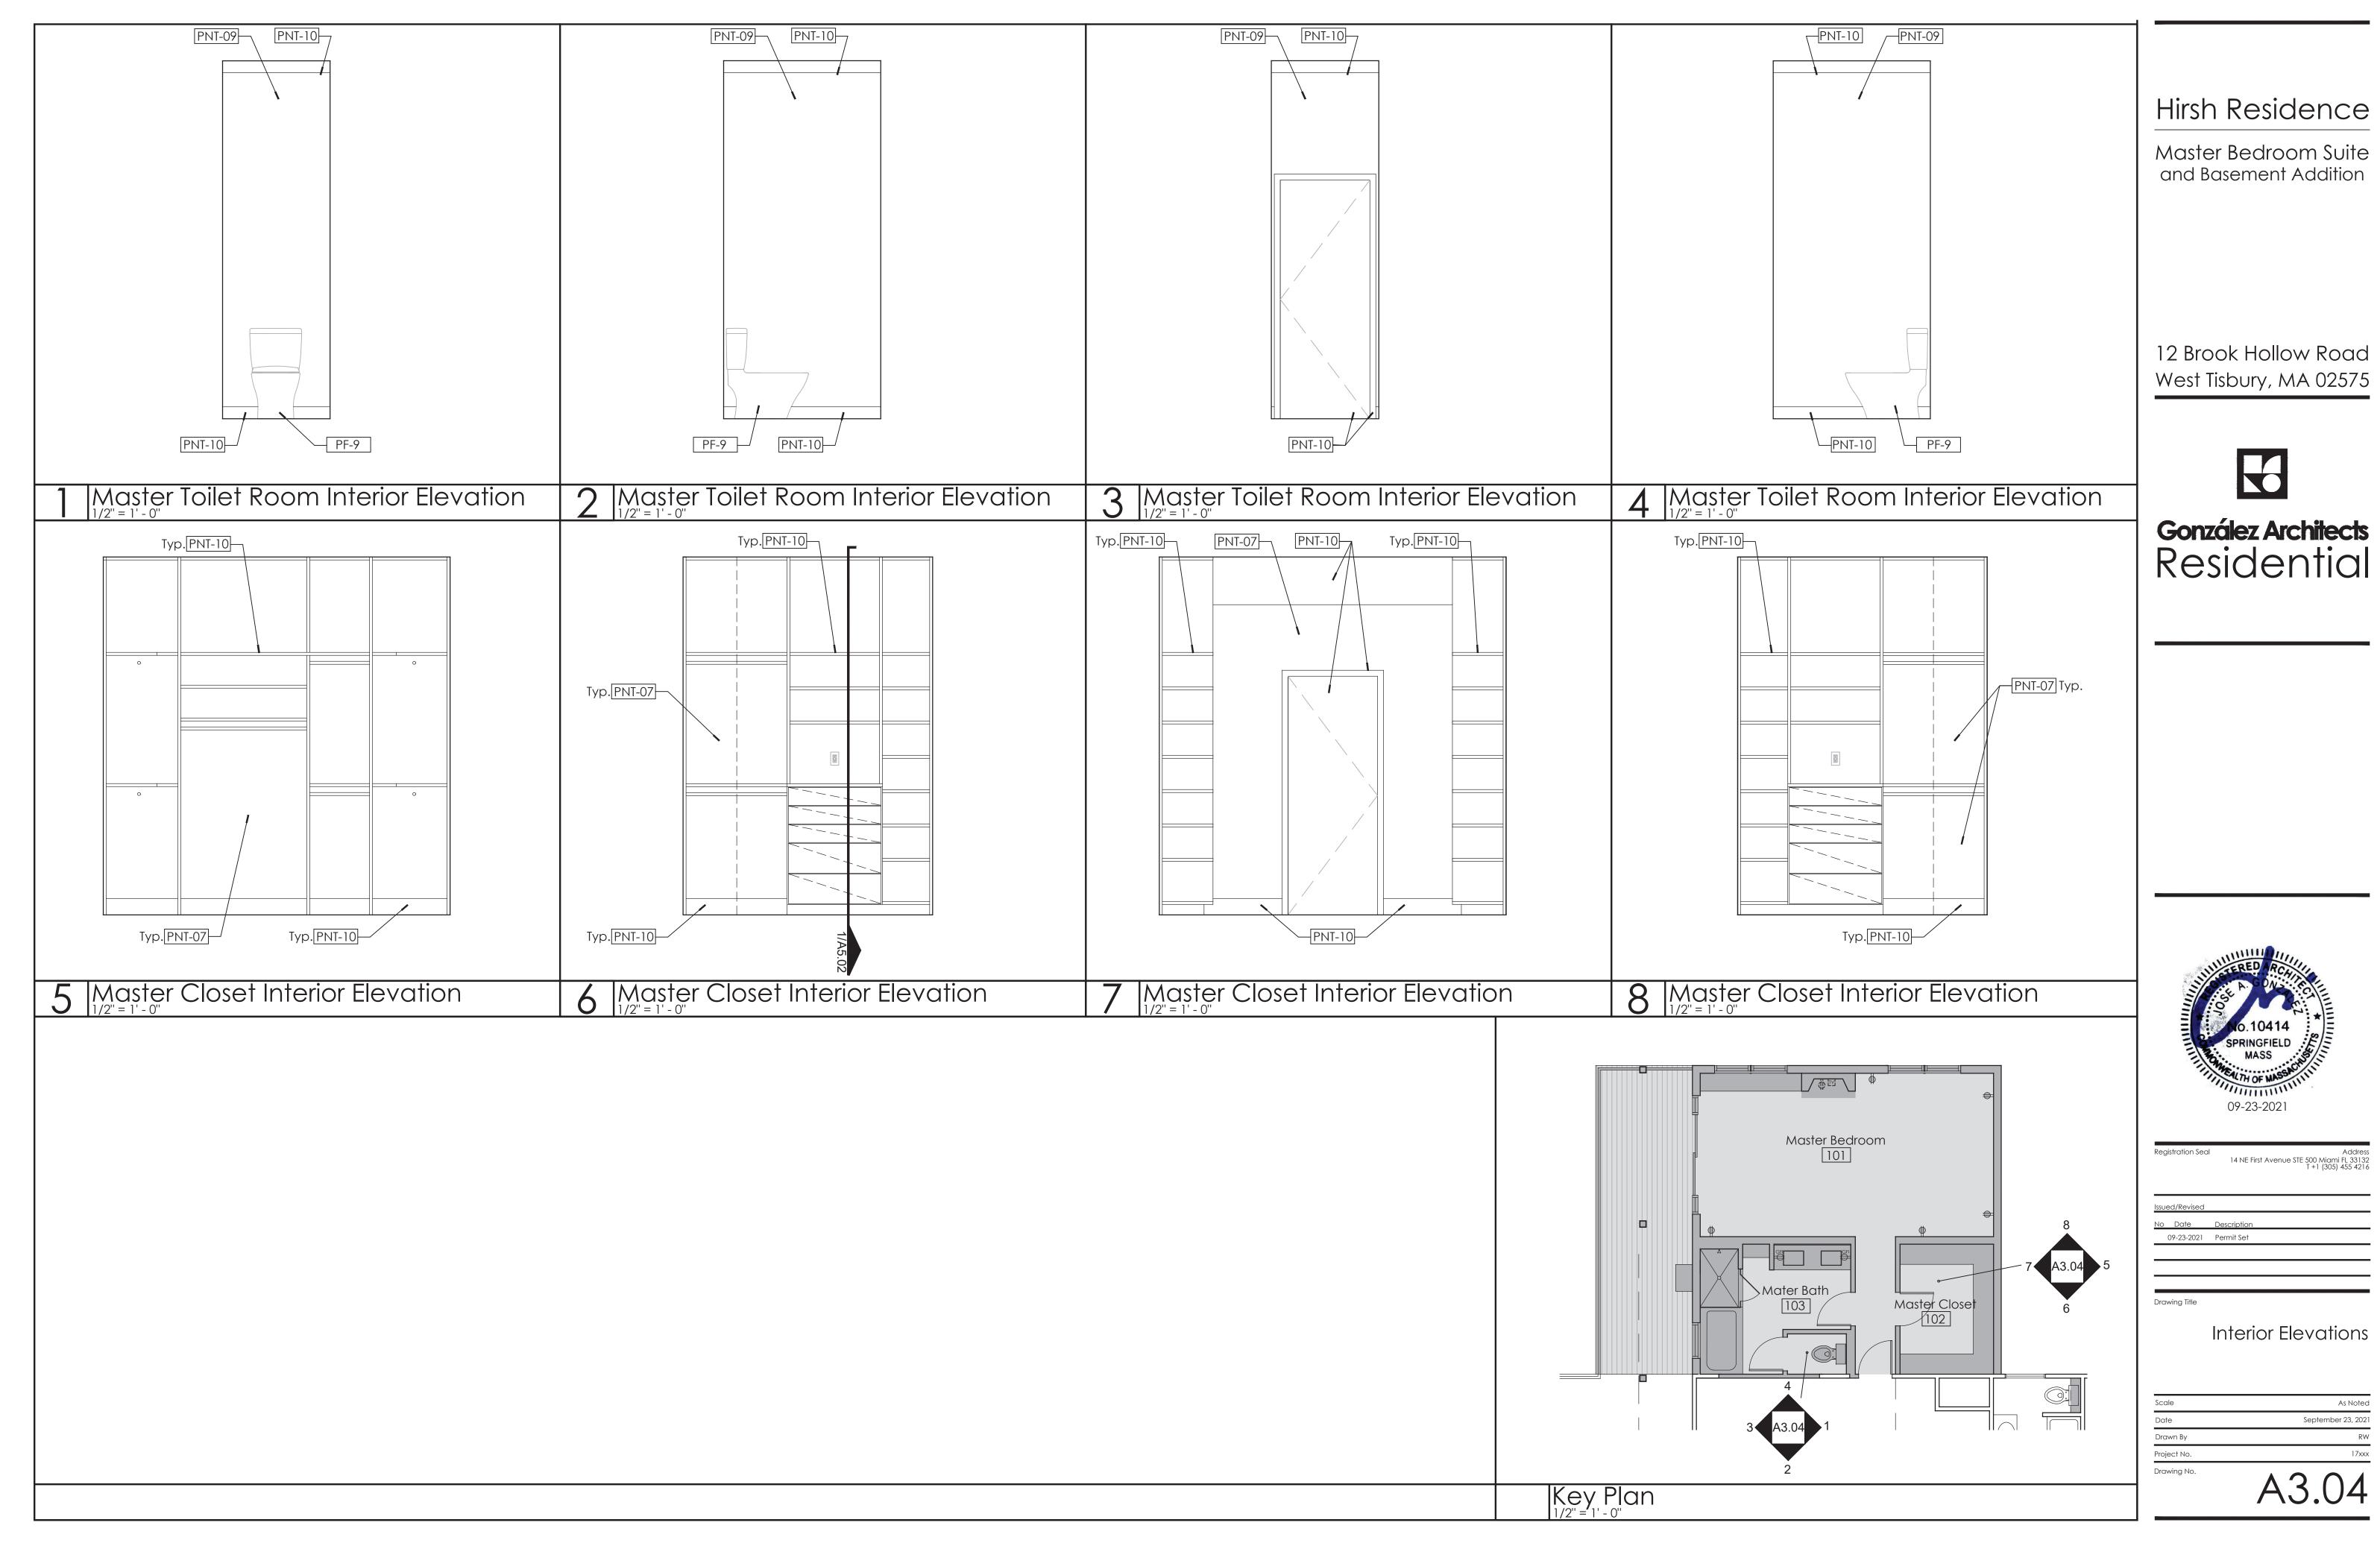


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Project No.	17xxx
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Date	September 23, 2021
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Master Bedroom Suite and Basement Addition

12 Brook Hollow Road West Tisbury, MA 02575

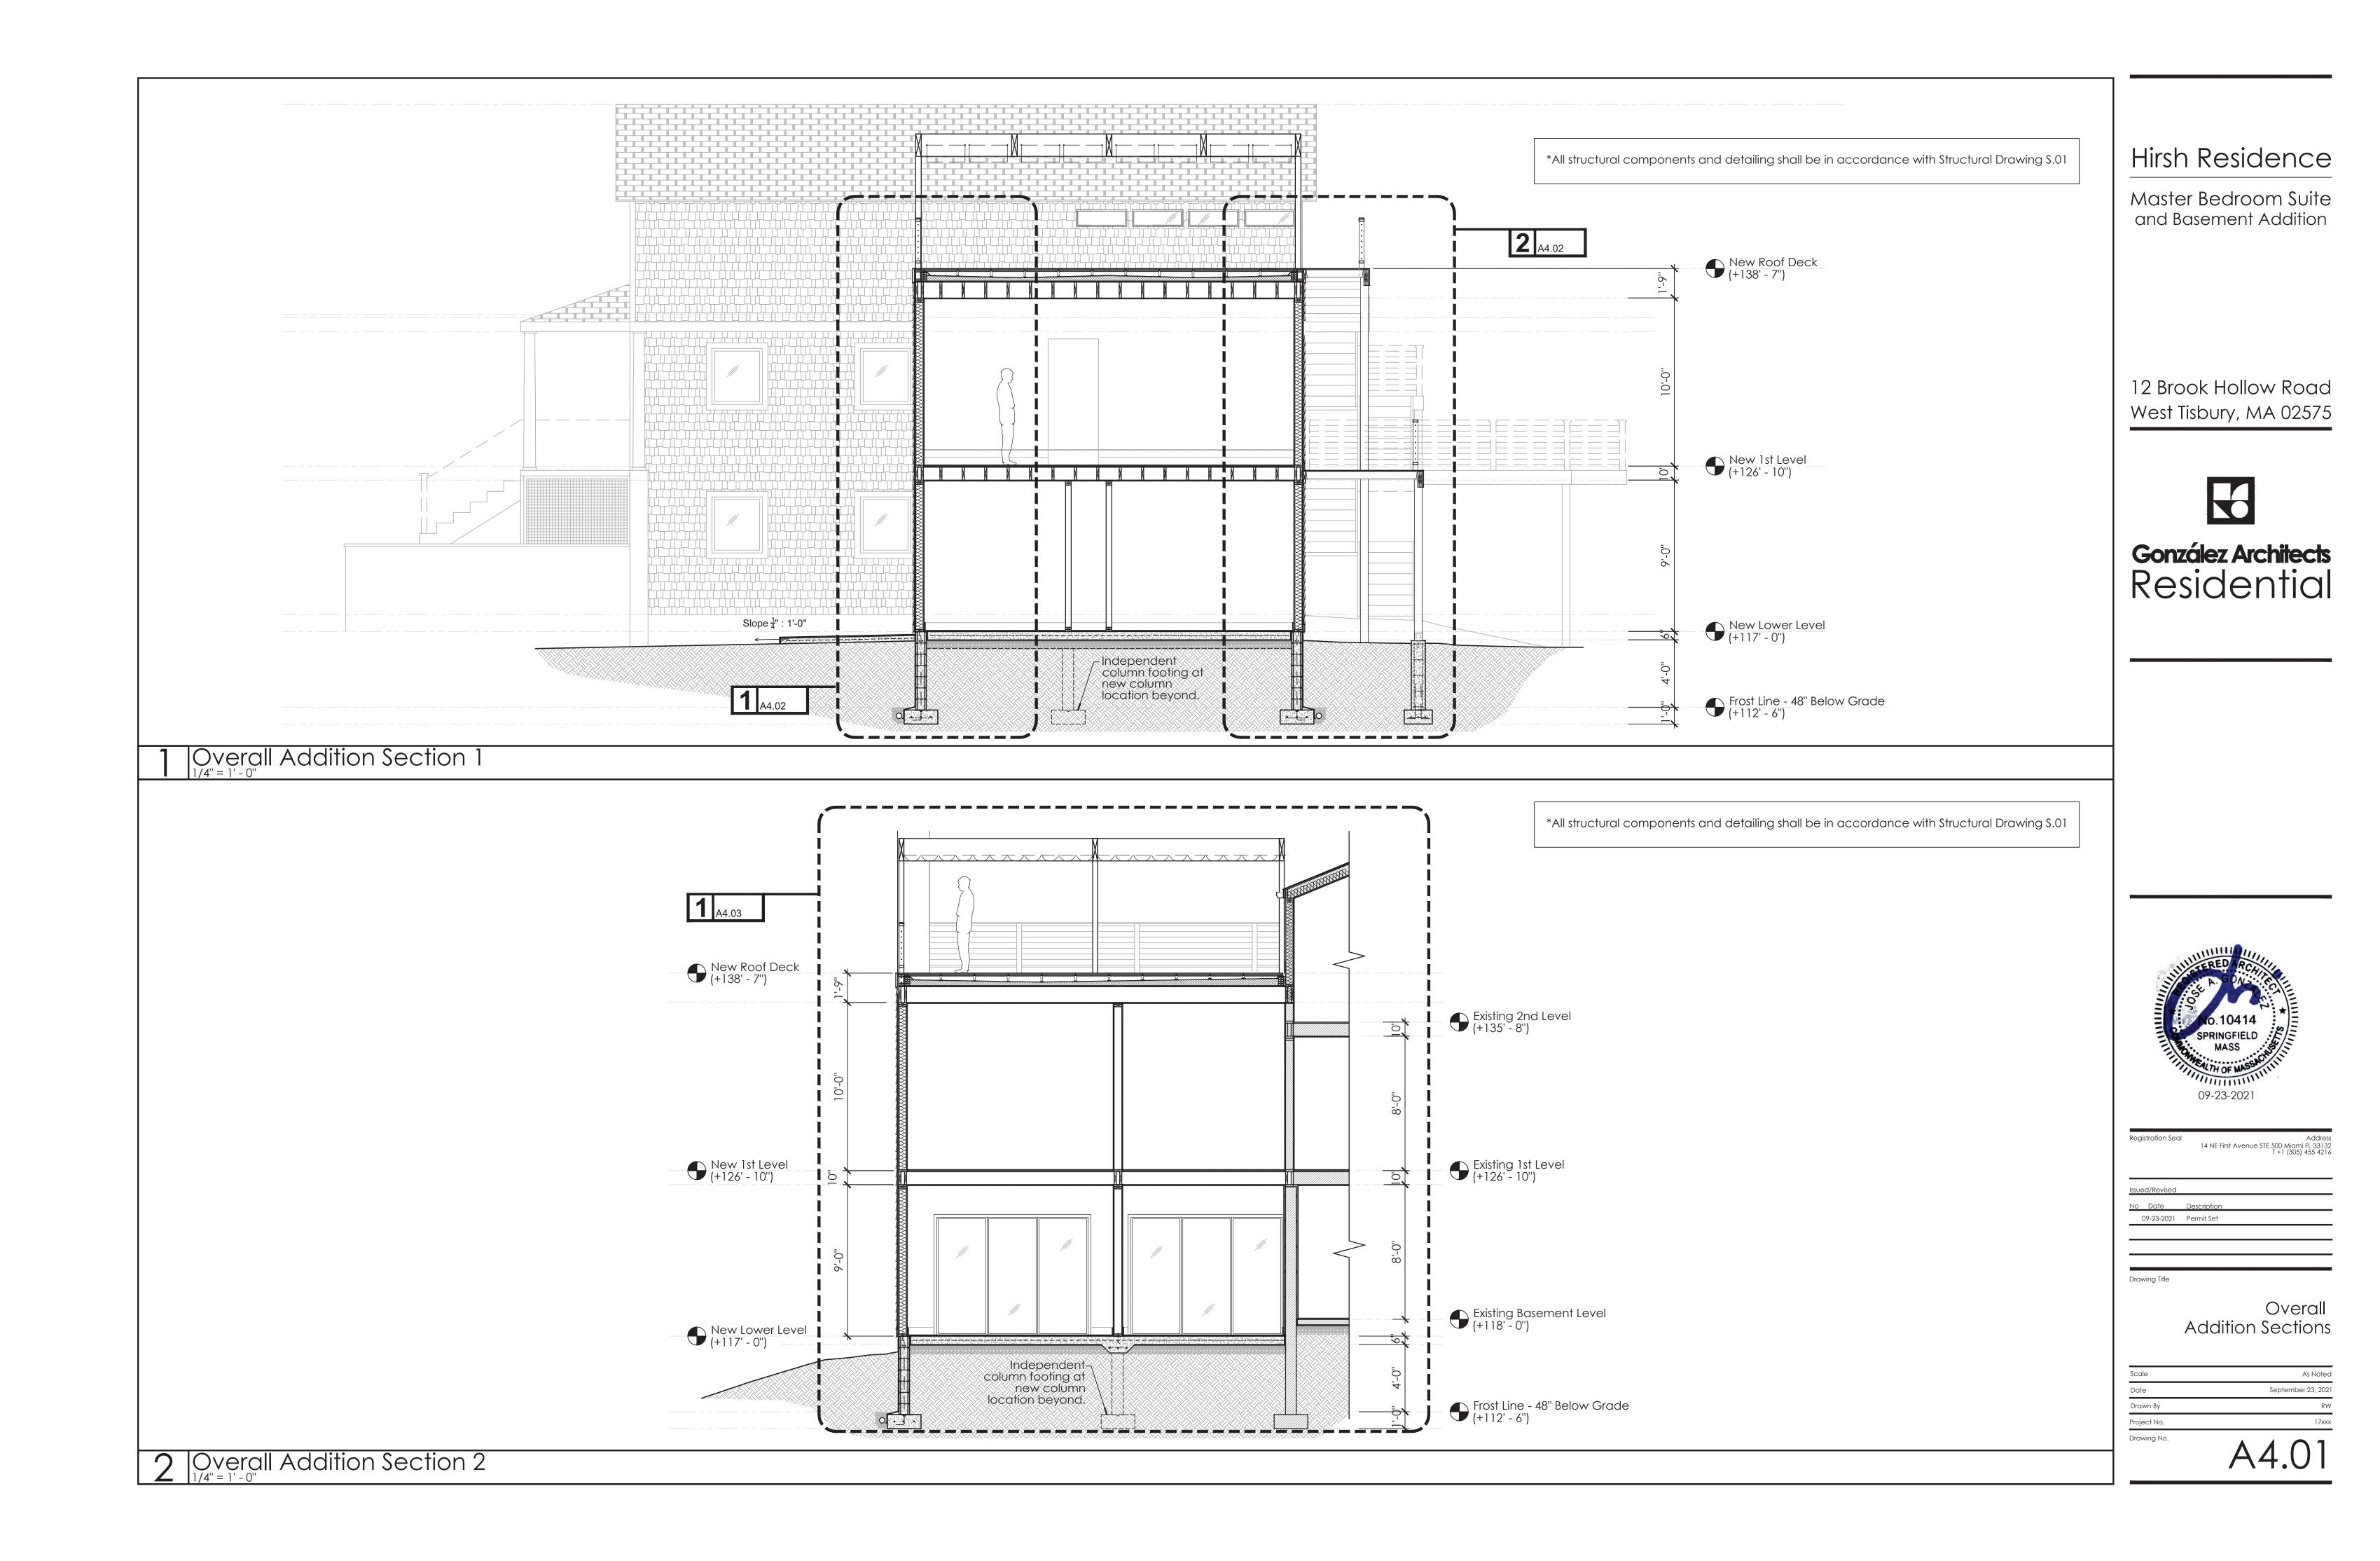
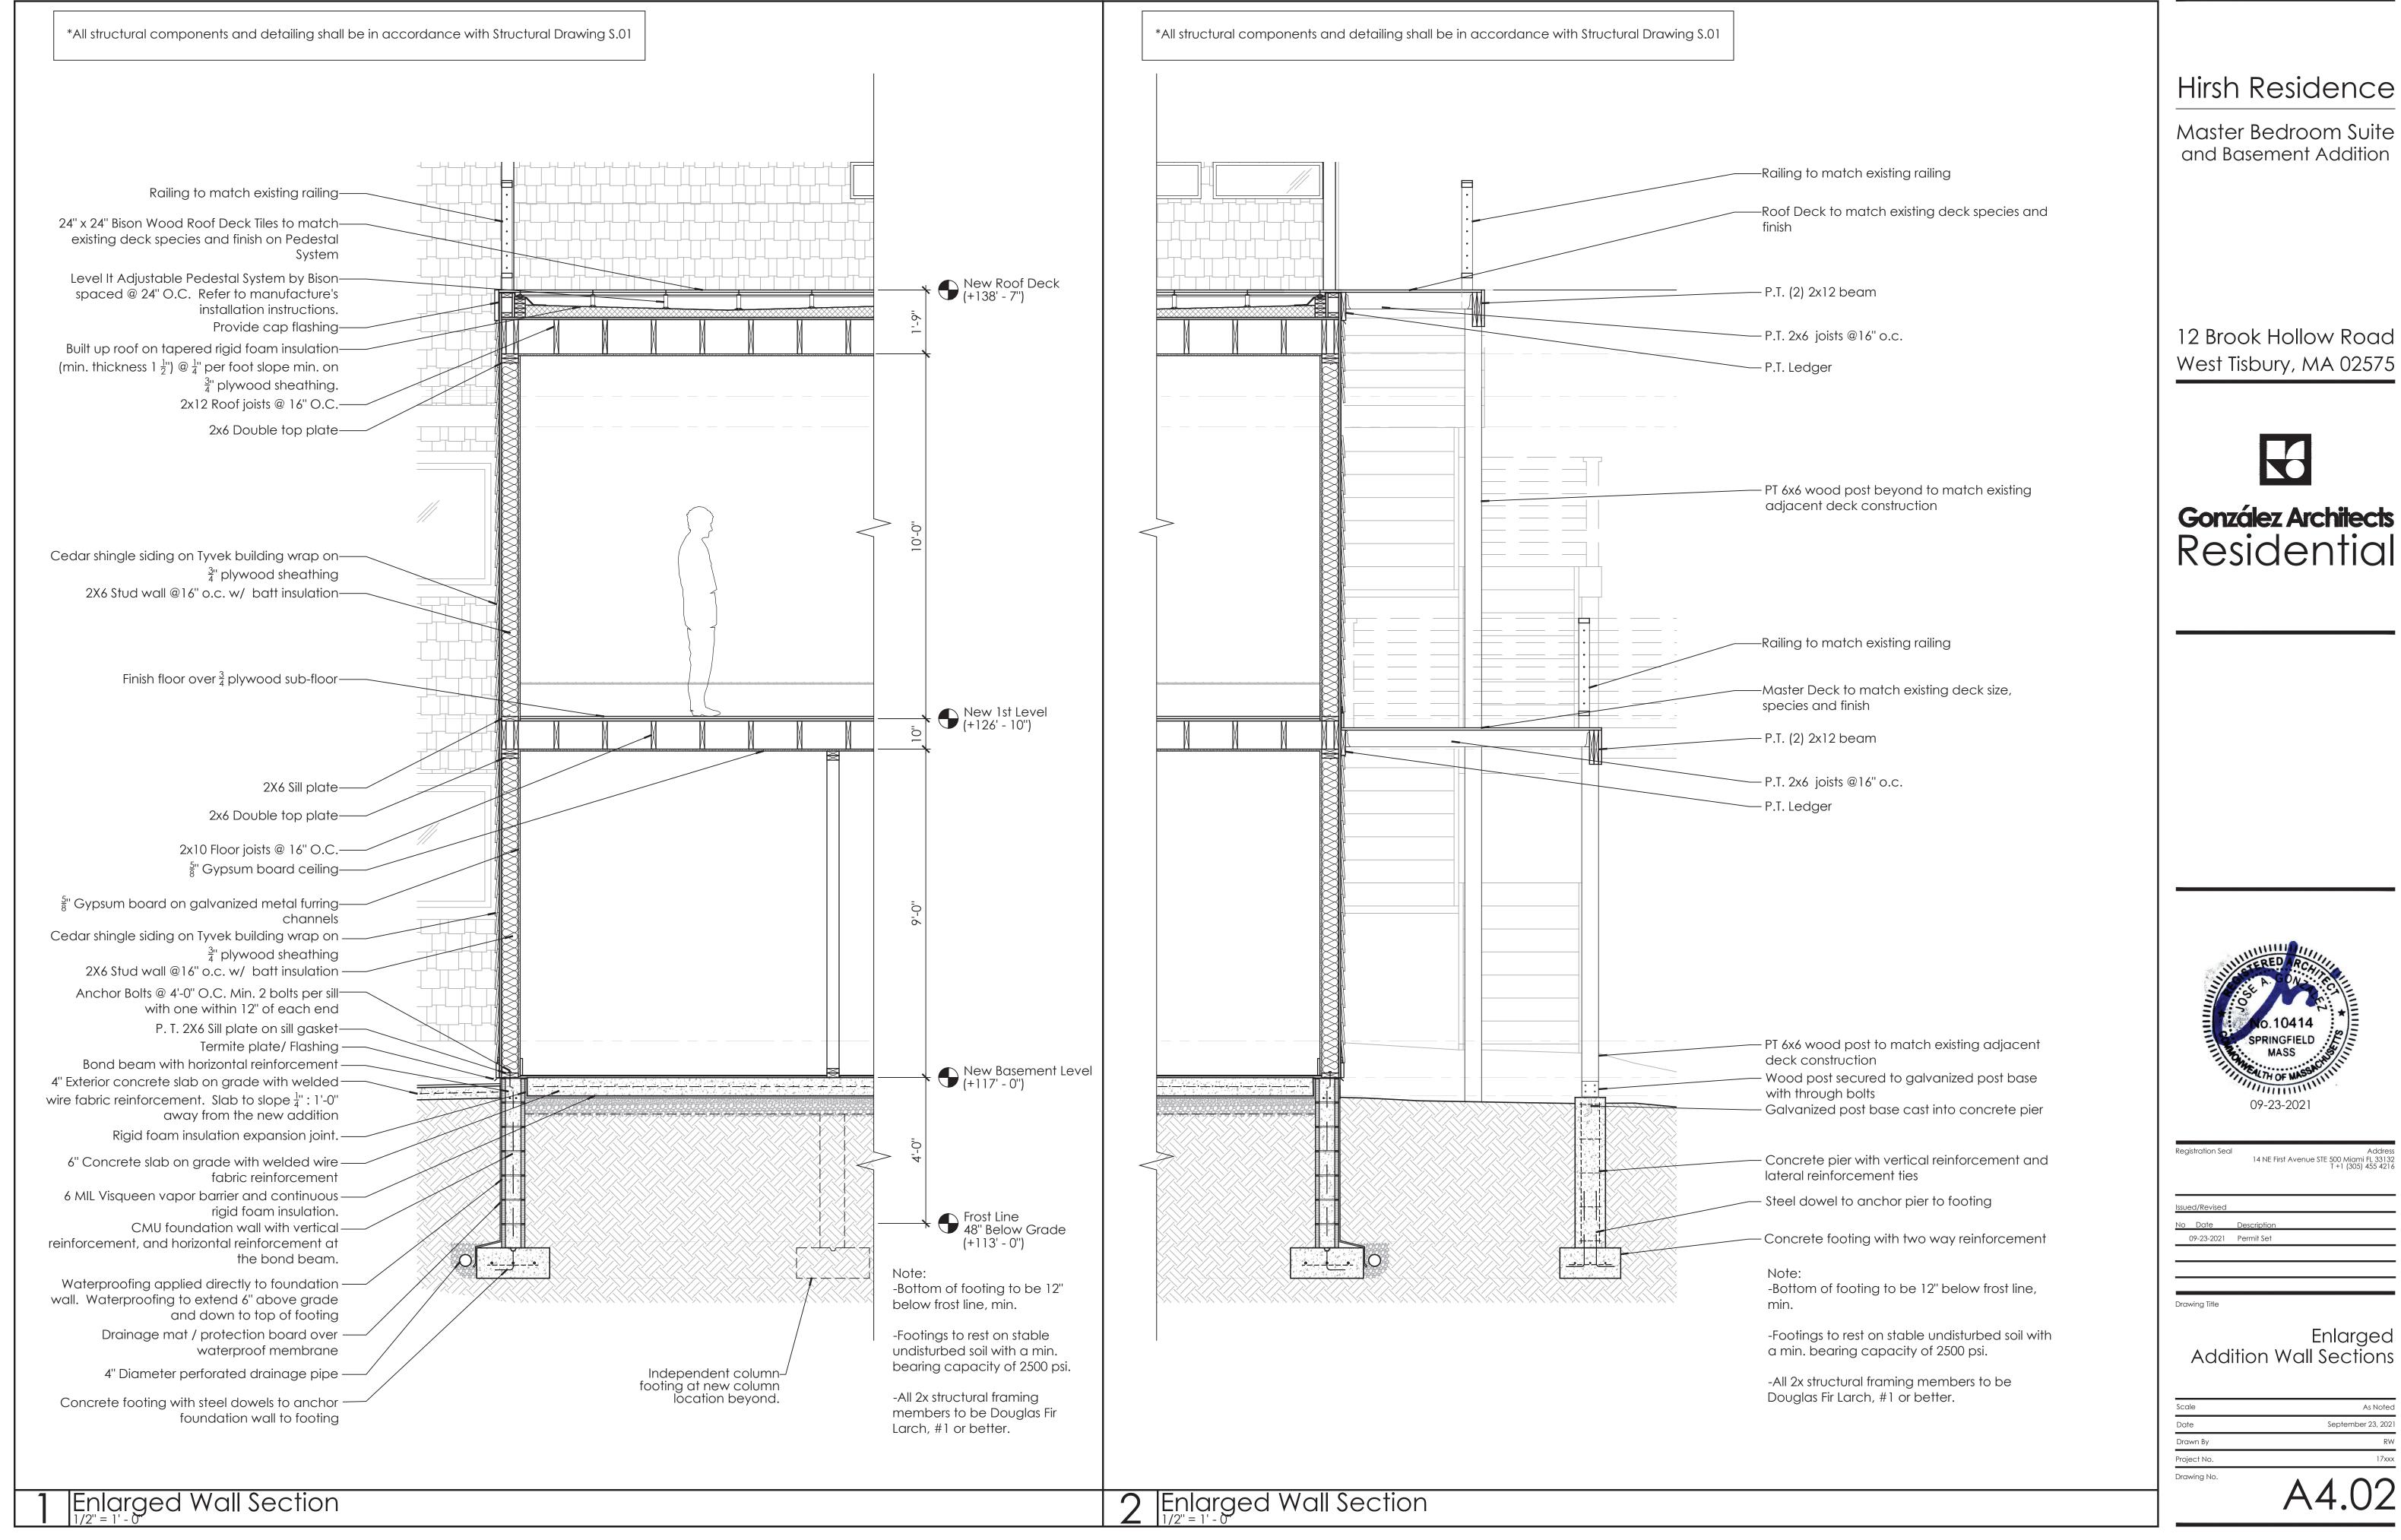
# González Architects Residential

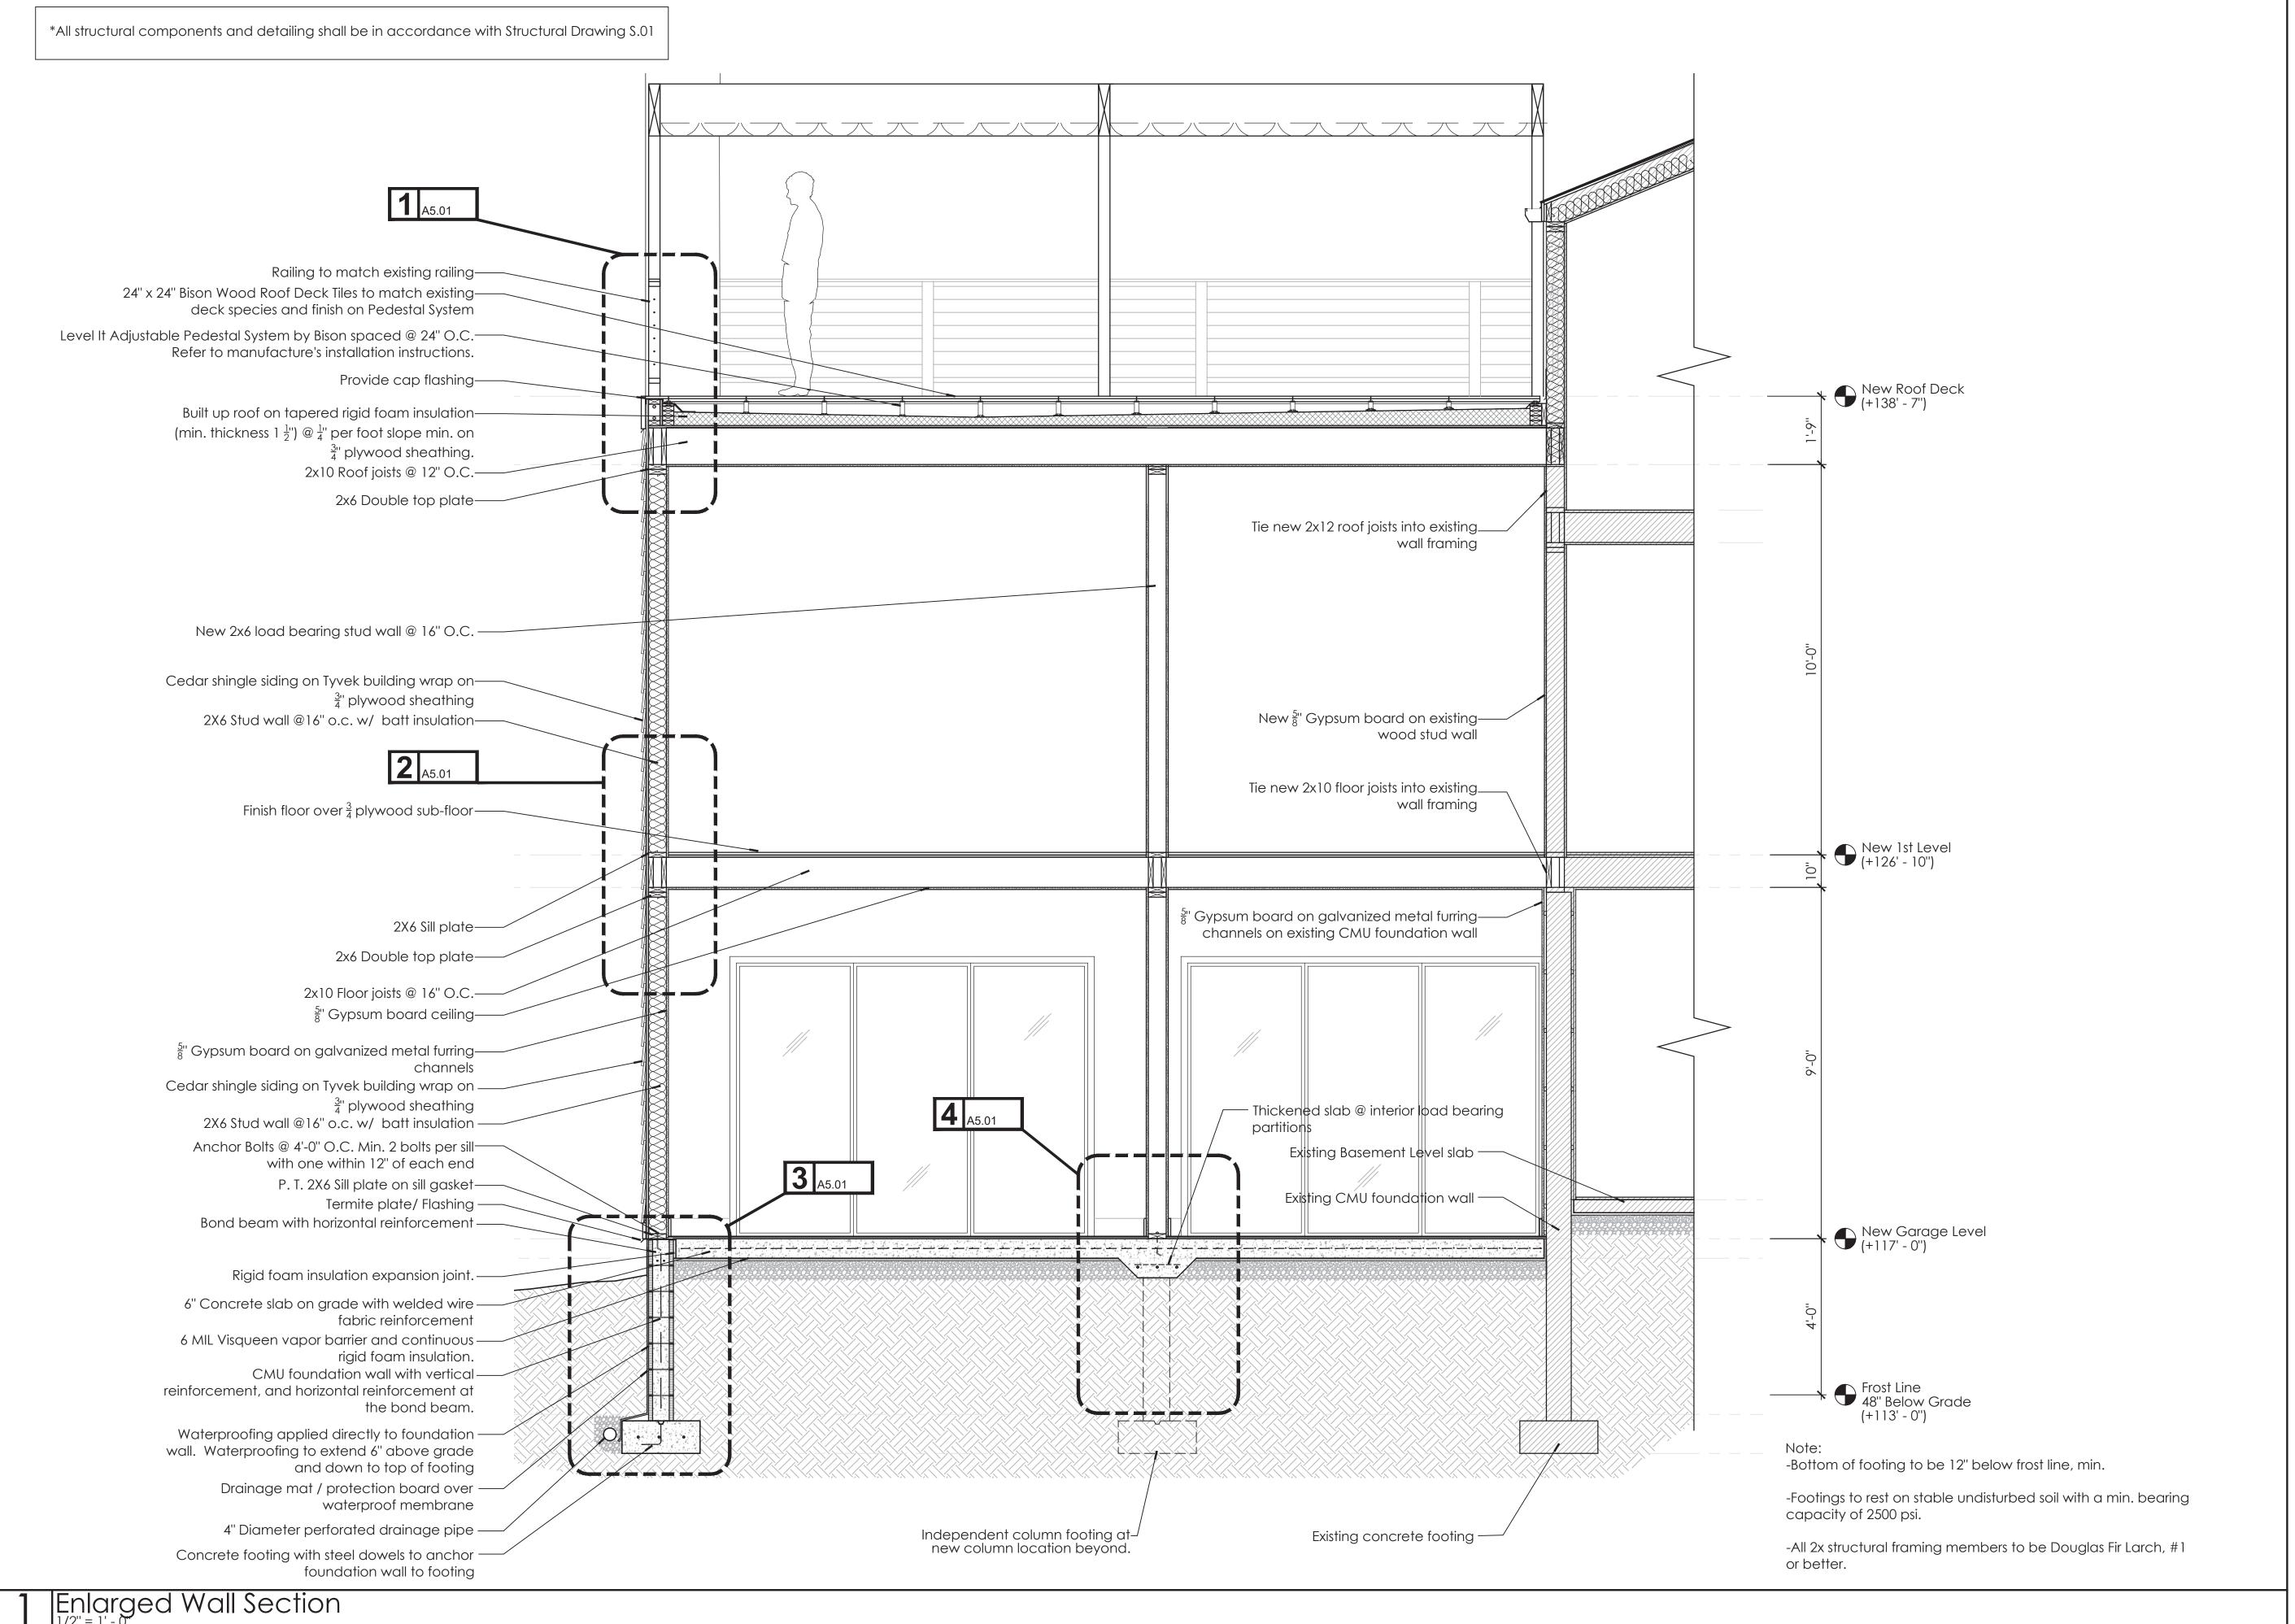

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No Date C	Description

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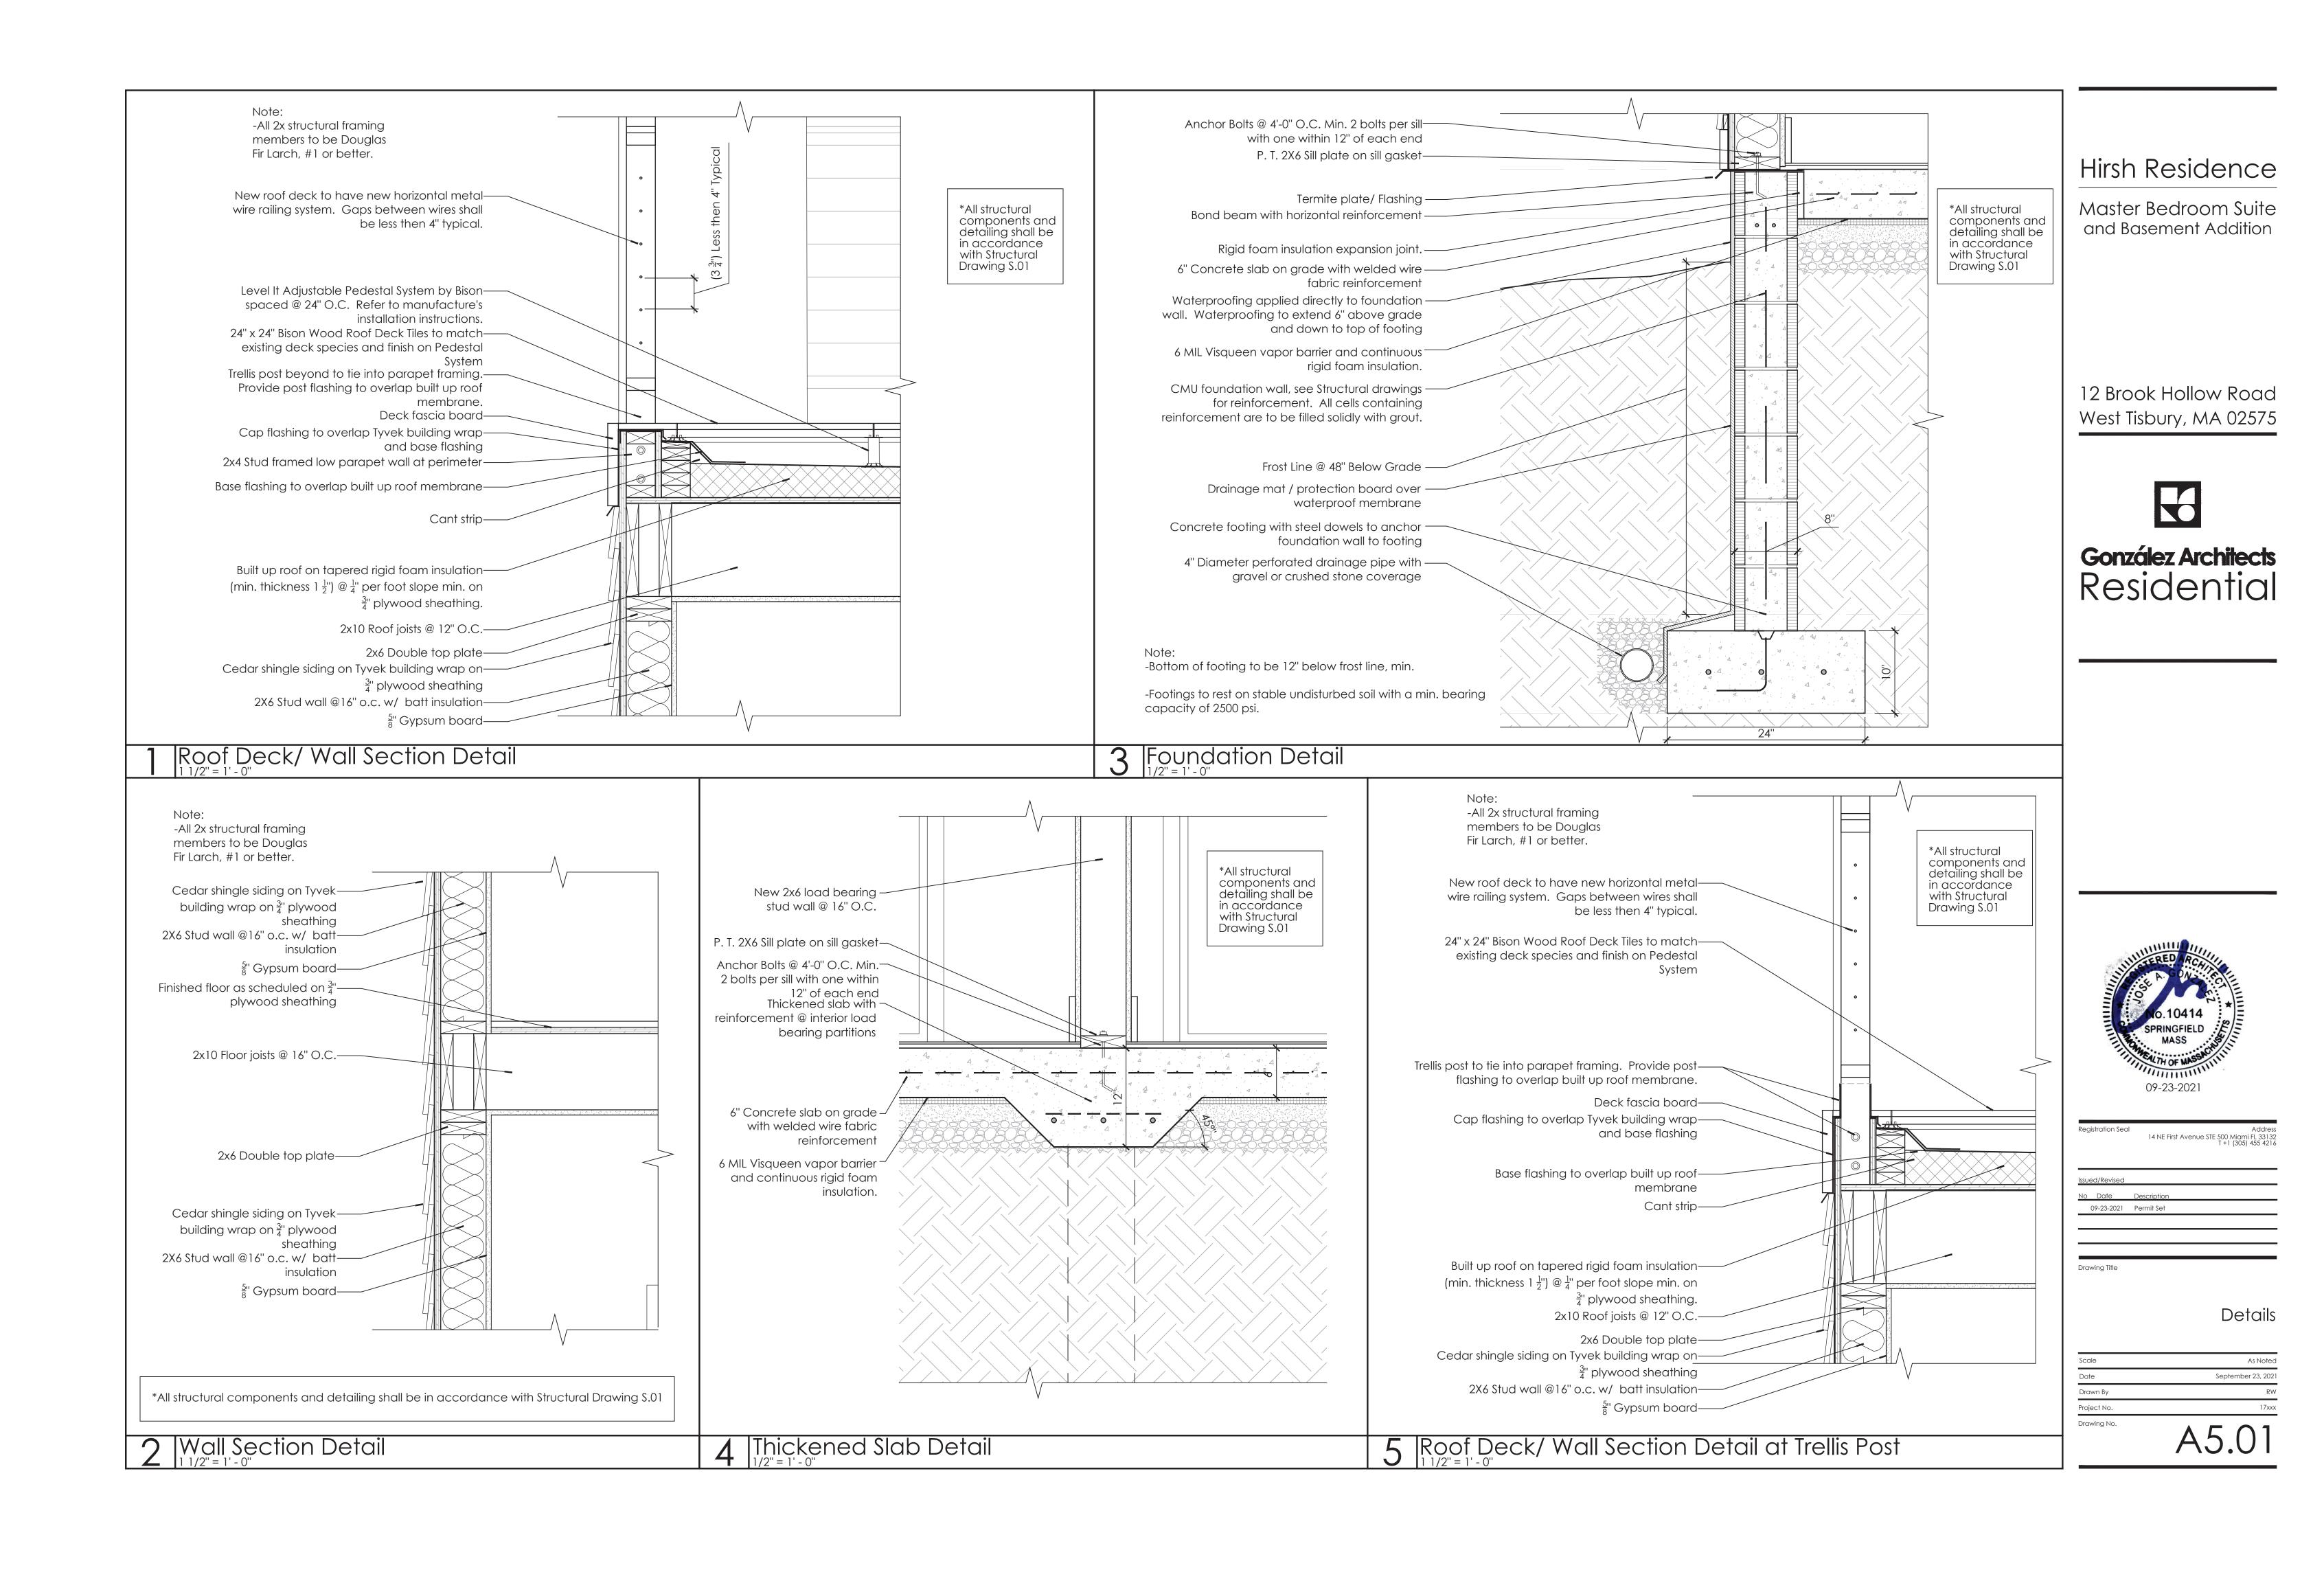
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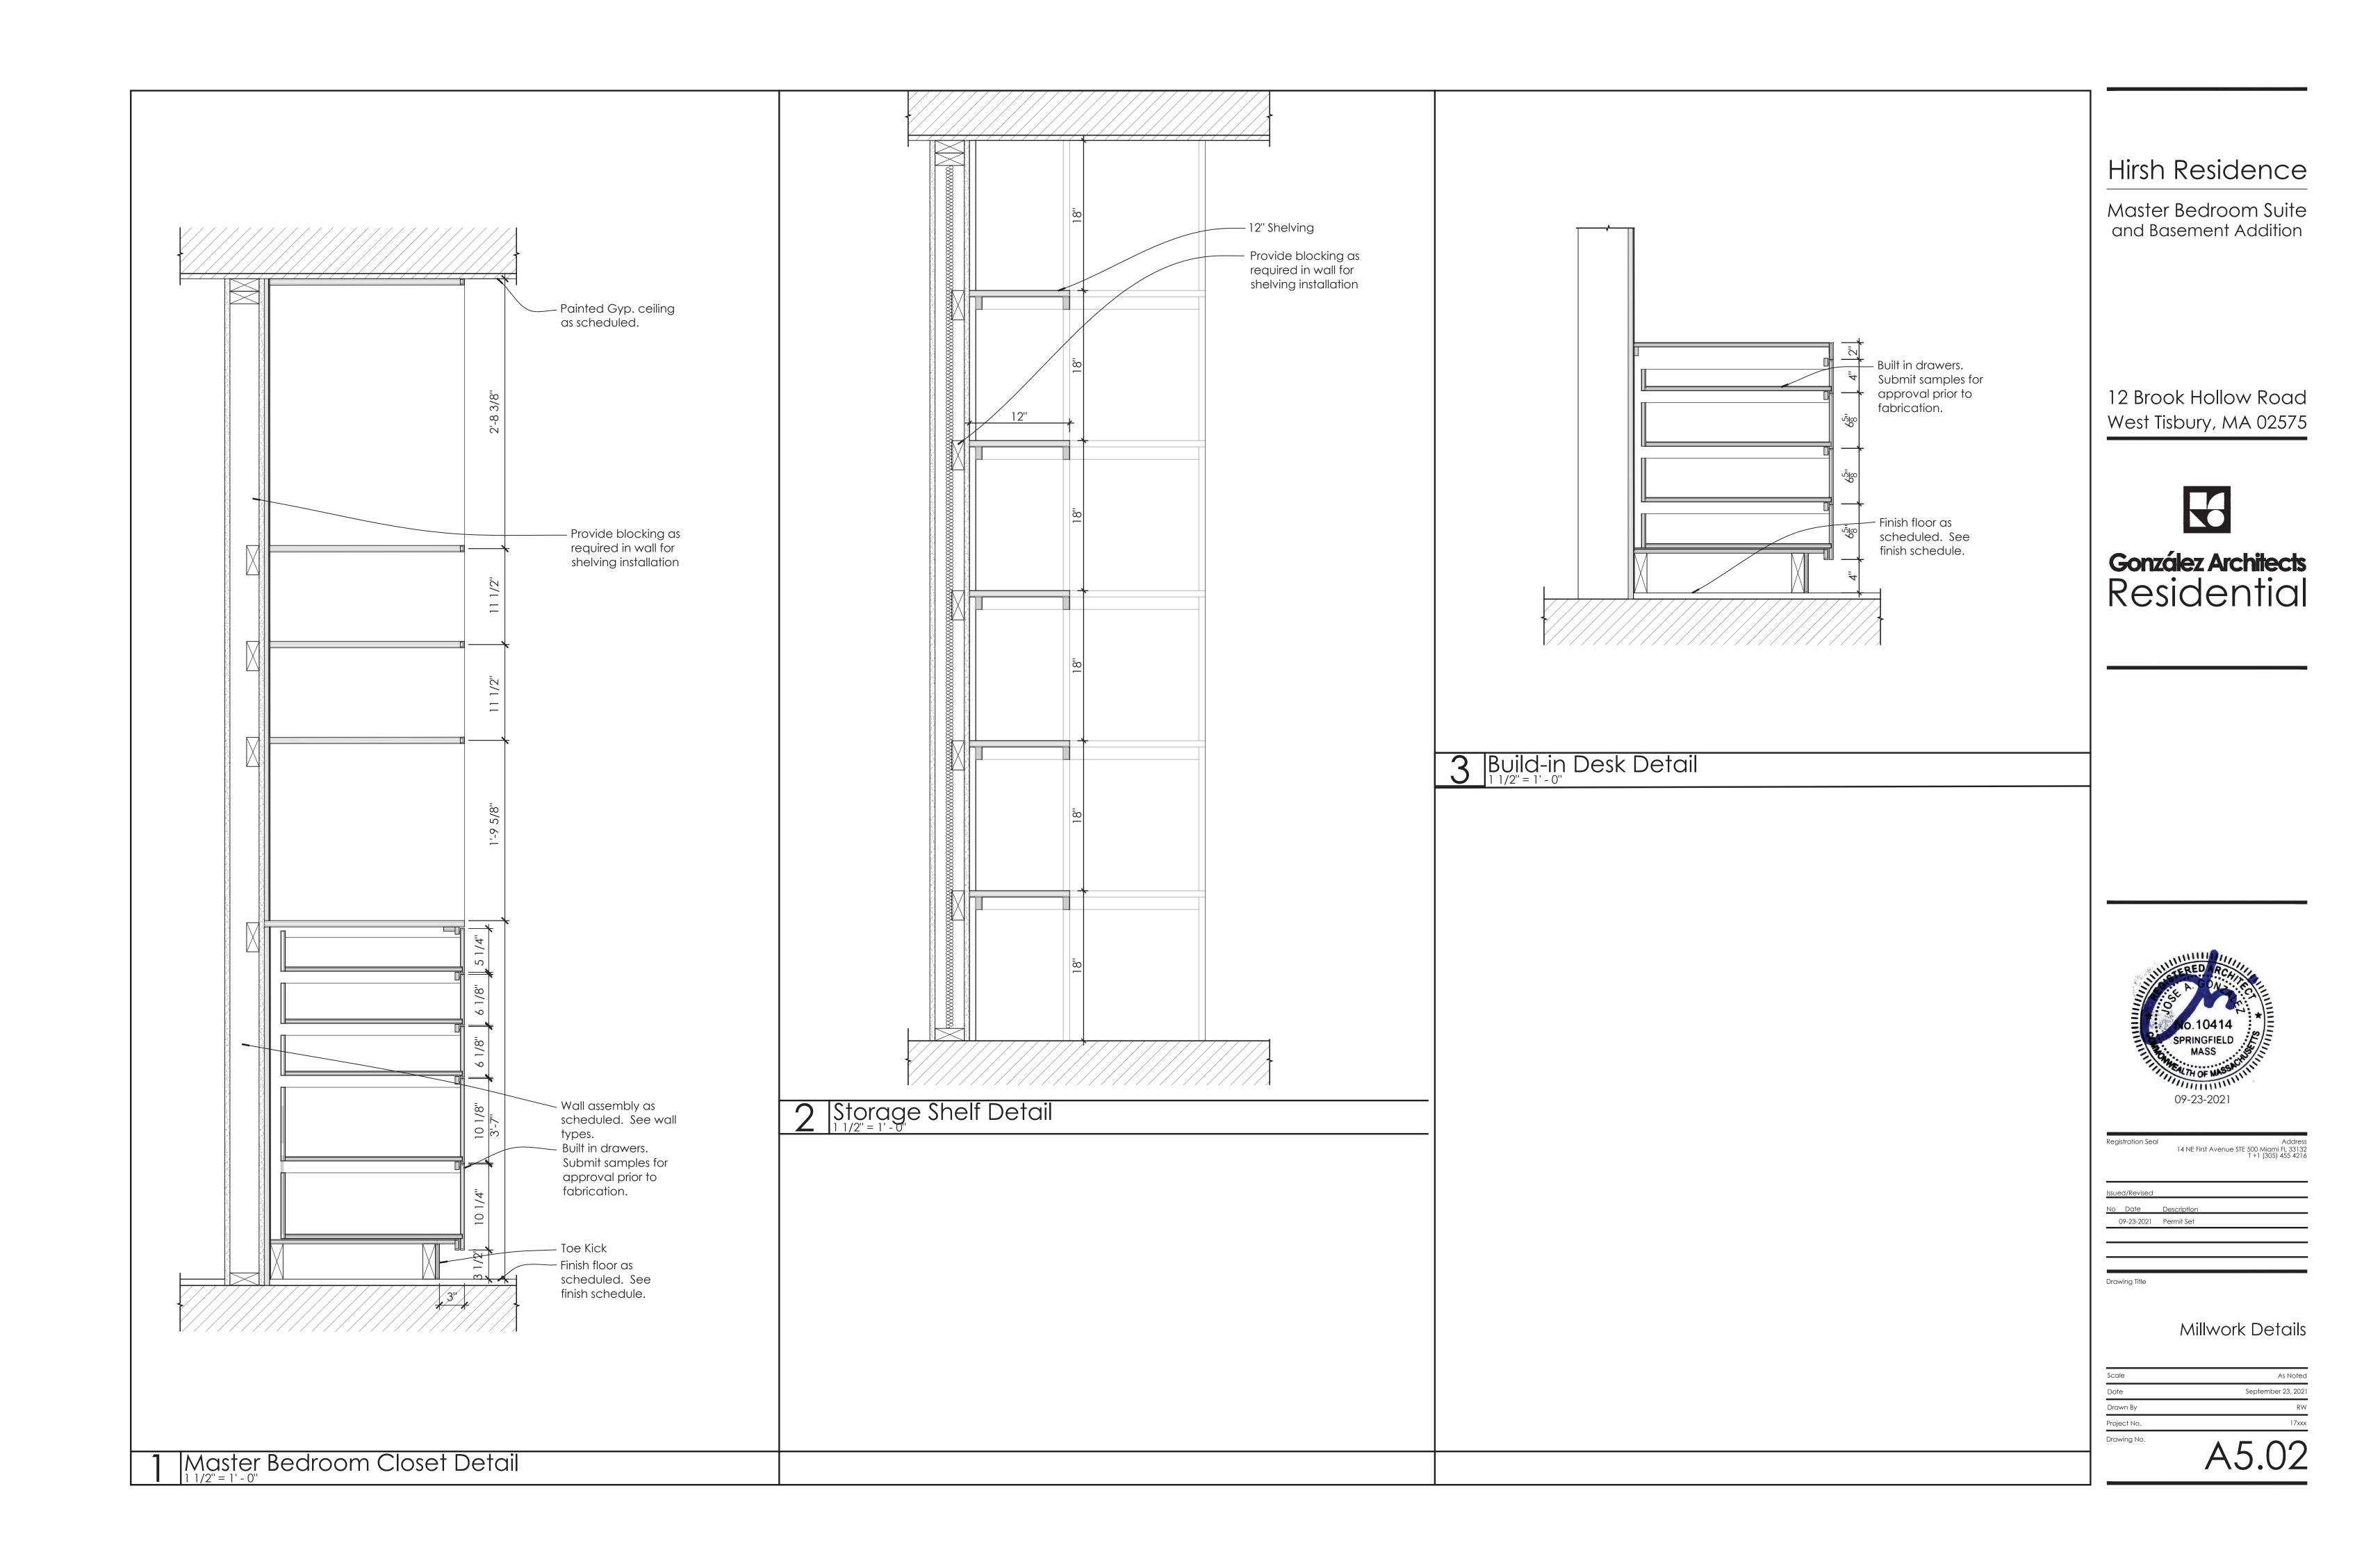
09-23-2021 Permit Set

Enlarged Building Section

Scale	As Noted
Date	September 23, 2021
Drawn By	RW
Project No.	17xxx
Drawing No.	1 0 0

A4.03





FINISH	SCHEDULE															
		FLOOR	S				WA	ALLS					CEII	LING		
RM	DESCRIPTION			NC	RTH	EA	\ST	SO	UTH	WE	ST					REMARKS
		MAT'L	BASE	MAT'L	FINISH	MAT'L	FINISH	MAT'L	FINISH	MAT'L	FINISH	MAT'L	HEIGHT	FINISH	CROWN	
001	BEDROOM	WD-01	WD. BASE-01	GYP	PNT-06	GYP	PNT-06	GYP	PNT-06	GYP	PNT-06	GYP	9'-0''	PNT-01	NA	*All finishes per clients selections
002	FITNESS	RB-01	WD.BASE-01 (6") PNT-10	GYP	PNT-03	GYP	PNT-03	GYP	PNT-03	GYP	PNT-03	GYP	9'-0''	PNT-01	WOOD PNT-10	*All finishes per clients selections
003	BATHROOM	TILE-01 TILE-02 (SHOWER	TILE BASE-02 ) (4") PNT-10	M.R. GYP/TILE-03	PNT-04 @ GYP	M.R. GYP/TILE-03	PNT-04 @ GYP	GYP/TILE-04 (WETWALL)	PNT-04 @ GYP	M.R. GYP	PNT-04	M.R. GYP	9'-0''	PNT-01	WOOD PNT-10	*All finishes per clients selections
004	STORAGE	CONCRETE	NA	GYP	PNT-05	GYP	PNT-05	GYP	PNT-05	GYP	PNT-05	GYP	9'-0''	PNT-01	WOOD PNT-10	*All finishes per clients selections
005	CORRIDOR	WD-01	WD.BASE-01	GYP	PNT-06	GYP	PNT-06	GYP	PNT-06	GYP	PNT-06	GYP	9'-0''	PNT-01	WOOD PNT-10	*All finishes per clients selections
101	MASTER BEDROOM	WD-01 (MATCH EXST.)	WD.BASE-01 (6") PNT-10	GYP	PNT-06	GYP	PNT-06	GYP	PNT-06	GYP	PNT-06	GYP	10'-0''	PNT-01	WOOD PNT-10	*All finishes per clients selections
102	MASTER CLOSET	WD-01 (MATCH EXST.)	WD.BASE-01 (6") PNT-10	GYP	PNT-07	GYP	PNT-07	GYP	PNT-07	GYP	PNT-07	GYP	10'-0''	PNT-01	WOOD PNT-10	*All finishes per clients selections
103	master Bathroom	STN-01 STN-02 (SHOWER	STONE ) BASE-03 (4")	GYP/STN-03 (WETWALL)	PNT-08 @ GYP	M.R. GYP	PNT-08	M.R. GYP	PNT-08	STN-04 (SHOWER)		M.R. GYP	10'-0''	PNT-01	WOOD PNT-10	*All finishes per clients selections
	MASTER TOILET ROOM	STN-01	STONE BASE-03 (4")	M.R. GYP	PNT-09	M.R. GYP	PNT-09	M.R. GYP	PNT-09	M.R. GYP	PNT-09	M.R. GYP	10'-0''	PNT-01	WOOD PNT-10	

# Finish Schedule

finish i	LEGEND					
MARK	DESCRIPTION	MANUFACTURER	STYLE	NUMBER	COLOR	REMARKS
WD-01	WOOD FLOORING	T.B.D.	T.B.D.	T.B.D.	T.B.D.	*TO MATCH EXISTING FLOORING
RB-01	RUBBER FLOORING	ECORE	ECOFIT	T.B.D.	T.B.D.	*TO MATCH EXISTING FLOORING
BASE-01	6" WOOD BASE	N/A	1x6- SOLID WOOD	N/A	PT-10	
BASE-02	4" TILE BASE	N/A	TO MATCH TILE-01	N/A	NA	*FINISHES PER CLIENT'S SELECTIONS
BASE-03	4" STONE BASE	N/A	TO MATCH STN-01	N/A	NA	*FINISHES PER CLIENT'S SELECTIONS
TILE-1	BATHROOM 003 FLOOR	T.B.D.	T.B.D.	T.B.D.	T.B.D.	*FINISHES PER CLIENT'S SELECTIONS
TILE-2	BATHROOM 003 SHOWER FLOOR	T.B.D.	T.B.D.	T.B.D.	T.B.D.	*FINISHES PER CLIENT'S SELECTIONS
TILE-3	BATHROOM 003 SHOWER WALL	T.B.D.	T.B.D.	T.B.D.	T.B.D.	*FINISHES PER CLIENT'S SELECTIONS
TILE-4	BATHROOM 003 WET WALL	T.B.D.	T.B.D.	T.B.D.	T.B.D.	*FINISHES PER CLIENT'S SELECTIONS
STN-1	MASTER BATHROOM FLOOR	T.B.D.	T.B.D.	T.B.D.	T.B.D.	*FINISHES PER CLIENT'S SELECTIONS
STN-2	MASTER BATHROOM SHOWER FLOOR	T.B.D.	T.B.D.	T.B.D.	T.B.D.	*FINISHES PER CLIENT'S SELECTIONS
STN-3	MASTER BATHROOM WET WALL	T.B.D.	T.B.D.	T.B.D.	T.B.D.	*FINISHES PER CLIENT'S SELECTIONS
STN-4	MASTER BATHROOM SHOWER WALL	T.B.D.	T.B.D.	T.B.D.	T.B.D.	*FINISHES PER CLIENT'S SELECTIONS
STN-5	PATIO FLOOR	T.B.D.	T.B.D.	T.B.D.	T.B.D.	*FINISHES PER CLIENT'S SELECTIONS
PNT-1	CEILING FINSIH THROUGHOUT	T.B.D.	T.B.D.	T.B.D.	T.B.D.	*FINISHES PER CLIENT'S SELECTIONS
PNT-2	GARAGE WALL FINISH	T.B.D.	T.B.D.	T.B.D.	T.B.D.	*FINISHES PER CLIENT'S SELECTIONS
PNT-3	FITNESS ROOM WALL FINISH	T.B.D.	T.B.D.	T.B.D.	T.B.D.	*FINISHES PER CLIENT'S SELECTIONS
PNT-4	BATHROOM 003 WALL FINISH	T.B.D.	T.B.D.	T.B.D.	T.B.D.	*FINISHES PER CLIENT'S SELECTIONS
PNT-5	STORAGE WALL FINISH	T.B.D.	T.B.D.	T.B.D.	T.B.D.	*FINISHES PER CLIENT'S SELECTIONS
PNT-6	MASTER BEDROOM WALL FINISH	T.B.D.	T.B.D.	T.B.D.	T.B.D.	*FINISHES PER CLIENT'S SELECTIONS
PNT-7	MASTER CLOSET WALL FINISH	T.B.D.	T.B.D.	T.B.D.	T.B.D.	*FINISHES PER CLIENT'S SELECTIONS
PNT-8	MASTER BATHROOM WALL FINISH	T.B.D.	T.B.D.	T.B.D.	T.B.D.	*FINISHES PER CLIENT'S SELECTIONS
PNT-9	MASTER TOILET ROOM WALL FINISH	T.B.D.	T.B.D.	T.B.D.	T.B.D.	*FINISHES PER CLIENT'S SELECTIONS
PNT-10	BASE, CROWN MOLDING, DOORS AND TRIM FINISH	T.B.D.	T.B.D.	T.B.D.	T.B.D.	*FINISHES PER CLIENT'S SELECTIONS

# Hirsh Residence

Master Bedroom Suite and Basement Addition

12 Brook Hollow Road West Tisbury, MA 02575



# González Architects Residential



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Address

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Drawing Title

Finish Schedule and Legend

Scale	As Not					
Date	September 23, 20					
Drawn By	R					
Project No.	17x					
Drawing No.						

A6.0

MARK	DESCRIPTION	MANUFACTURER	STYLE	NUMBER	COLOR	REMARKS
T-1	recessed down light					*FIXTURES PER CLIENT'S SELECTIONS
T-2	EXTERIOR WALL MOUNT LIGHT					*FIXTURES PER CLIENT'S SELECTIONS
Г-3	SCONCES @ MASTER BATHROOM					*FIXTURES PER CLIENT'S SELECTIONS
1R-1	LIGHTED MIRROR @ BATHROOM 003					*FIXTURES PER CLIENT'S SELECTIONS
CF-01	CEILING FAN W/ INTEGRATED LIGHT					*FIXTURES PER CLIENT'S SELECTIONS

Master Bedroom Suite and Basement Addition

12 Brook Hollow Road West Tisbury, MA 02575

González Architects
Residential

# 1 Lighting Legend

	IG FIXTURE LEGEND	LACATIONI	OLIANITITY	MANUFACTURER STYLE	NUMBER	COLOR/ FINISH	REMARKS
MARK I	DESCRIPTION	LOCATION	QUANTITY	MANUFACTURER STYLE	INUMBER	COLOR/TINISTT	REIVIARNS
			(1)				
PF-1	SHOWER HEAD	BATHROOM 003	(1)				*PLUMBING FIXTURES PER CLIENT'S SELECTIONS
PF-2	SHOWER TRIM	BATHROOM 003	(1)				*PLUMBING FIXTURES PER CLIENT'S SELECTIONS
PF-3	TIOLET	BATHROOM 003	(1)				*PLUMBING FIXTURES PER CLIENT'S SELECTIONS
PF-4	VANITY SINK	BATHROOM 003	(1)				*PLUMBING FIXTURES PER CLIENT'S SELECTIONS
PF-5	VANITY FAUCET SET	BATHROOM 003	(1)				*PLUMBING FIXTURES PER CLIENT'S SELECTIONS
PF-6	SHOWER HEAD	MASTER BATH 103	(1)				*PLUMBING FIXTURES PER CLIENT'S SELECTIONS
PF-7	SHOWER TRIM	MASTER BATH 103	(1)				*PLUMBING FIXTURES PER CLIENT'S SELECTIONS
PF-8	hand shower and diverter	MASTER BATH 103	(1)				*PLUMBING FIXTURES PER CLIENT'S SELECTIONS
PF-9	TIOLET	MASTER BATH 103	(1)				*PLUMBING FIXTURES PER CLIENT'S SELECTIONS
PF-10 '	VANITY SINK	MASTER BATH 103	(2)				*PLUMBING FIXTURES PER CLIENT'S SELECTIONS
PF-11 '	VANITY FAUCET SET	MASTER BATH 103	(2)				*PLUMBING FIXTURES PER CLIENT'S SELECTIONS
PF-12	BATHTUB	MASTER BATH 103	(1)				*PLUMBING FIXTURES PER CLIENT'S SELECTIONS
PF-13 [	BATHTUB FAUCET SET	MASTER BATH 103	(1)				*PLUMBING FIXTURES PER CLIENT'S SELECTIONS

# 2 Plumbing Fixture Legend



Registration Seal

Address

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No Date Description

09-23-2021 Permit Set

Drawing Title

Legends

Scale	As Note
Date	September 23, 202
Drawn By	RV
Project No.	17xx
Drawing No.	

A6.02


TAG	TYPE	SIZE ( w x h) LOCAT	ION	DESCRIPTION	MATERIAL	FINISHES	HEAD DTL.	JAMB DTL.	SILL DTL.	HARDWARE (SEE 5/A4.03)	REMARKS
000A	*	MATCH EXISTING FAMILY R	ООМ	EXTERIOR SLIDING DOOR (TO MATCH EXISTING DOOR)	SOLID WOOD	PAINT					*DOOR TYPE AND SIZE SHALL MATCH THE EXISTING DOOR THAT IS BEING REMOVED
001A	В	(36" x 80") BEDRO	ОМ	EXTERIOR SINGLE SWING DOOR	SOLID WOOD	PAINT					
001B	В	(36" x 80") BEDRO	ОМ	INTERIOR SINGLE SWING DOOR	SOLID WOOD	PAINT					
001C	D	(96" x 80") BEDRO	ОМ	INTERIOR SLIDING DOOR	SOLID WOOD	PAINT					
002A	В	(36" x 80") FITNESS/CC	RRIDOR	INTERIOR SINGLE SWING DOOR	SOLID WOOD	PAINT					
002B	В	(36" x 80") FITNE	SS	INTERIOR SINGLE SWING DOOR	SOLID WOOD	PAINT					
002C	А	(84" x 98") FITNE	SS	EXTERIOR SINGLE SLIDING DOOR WITH SIDELIGHTS	WOOD/ GLASS	PAINT					
002D	А	(84" x 108") FITNE	SS	EXTERIOR SLIDING DOOR	WOOD/ GLASS	PAINT					
003A	В	(30" x 80") BATH (	003	EXTERIOR SINGLE SWING DOOR	SOLID WOOD	PAINT					
003B	В	(30" x 80") BATH 003 /	FITNESS	INTERIOR SINGLE SWING DOOR	SOLID WOOD	PAINT					
004A	В	(36" x 80") STORA	GE	EXTERIOR SINGLE SWING DOOR	SOLID WOOD	PAINT					
005A	В	(36" x 80") CORRII	OOR	EXTERIOR SINGLE SWING DOOR	SOLID WOOD	PAINT					
005B	D	(48" x 80") CORRII	OOR	INTERIOR SLIDING DOOR	SOLID WOOD	PAINT					
101A	С	(38" x *84") MASTER BE	DROOM	EXTERIOR DOUBLE SLIDING DOOR WITH SIDELIGHTS	WOOD/ GLASS	PAINT					*HEADER HEIGHT TO MATCH EXISTING ADJACENT EXTERIOR SLIDING DOORS
101B	В	(30" x 80") MASTER BE	DROOM	INTERIOR SINGLE SWING DOOR	SOLID WOOD	PAINT					
102A	В	(30" x 80") MASTER C	LOSET	INTERIOR SINGLE SWING DOOR	SOLID WOOD	PAINT					
103A	В	(30" x 80") MASTER	BATH	INTERIOR SINGLE SWING DOOR	SOLID WOOD	PAINT					
103B	В	(30" x 80") MASTER TOI	.ET ROOM	INTERIOR SINGLE SWING DOOR	SOLID WOOD	PAINT					

Master Bedroom Suite and Basement Addition

12 Brook Hollow Road West Tisbury, MA 02575



González Architects Residential

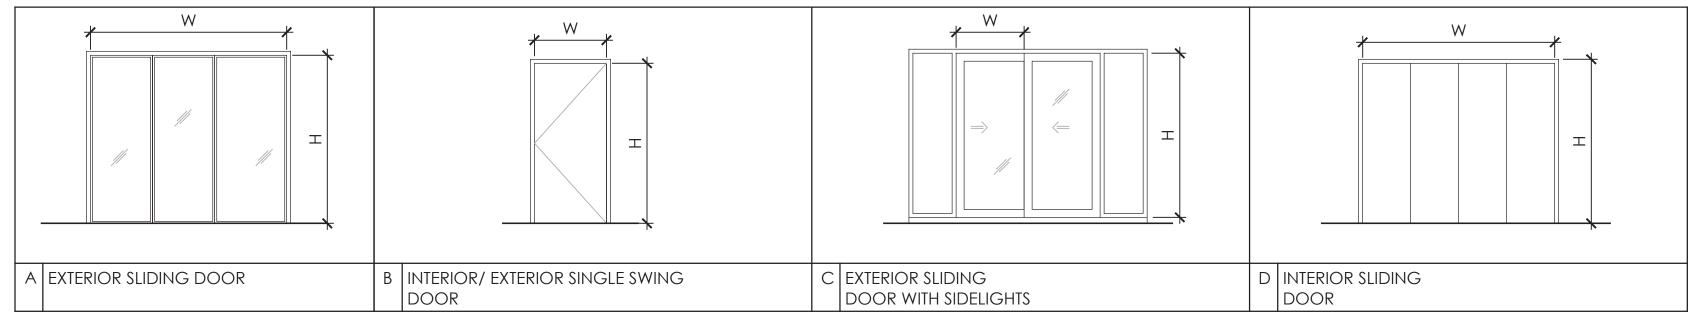

# 2 Door Types

WINDO	W SCHEDULE									
TAG	TYPE	SIZE ( w x h)	LOCATION	DESCRIPTION	MATERIAL	FINISHES	HEAD DTL.	JAMB DTL.	SILL DTL.	
A	DBL. HUNG	36" x 48"	FITNESS 002	DOUBLE HUNG WINDOW	GLASS/ WOOD	PAINT				
B	DBL. HUNG	32" x 48"	MASTER BEDROOM 101	DOUBLE HUNG WINDOW	GLASS/ WOOD	PAINT				
(C)	DBL. HUNG	32" x 36"	MASTER BEDROOM 101	DOUBLE HUNG WINDOW	GLASS/ WOOD	PAINT				
$\bigcirc$	FIXED	17" x *84"	MASTER BEDROOM 101	FIXED SIDE LIGHT	GLASS/ WOOD	PAINT				*HEADER HEIGHT TO MATCH EXISTING ADJACENT EXTERIOR SLIDING DOORS
E	DBL. HUNG	18" x 48"	BEDROOM 001	DOUBLE HUNG WINDOW	GLASS/ WOOD	PAINT				
F	FIXED	36" x 12"	LIVING ROOM	CLERESTORY WINDOW	GLASS/ WOOD	PAINT				
						'			1	

# 3 Window Schedules

36"	32"	32"	Varies	18"	36"
A 36" X 48" DOUBLE HUNG WINDOW	B 32" X 48" DOUBLE HUNG WINDOW	C 32" X 36" DOUBLE HUNG WINDOW	D FIXED SIDELIGHT WINDOW	E 18" X 48" DOUBLE HUNG WINDOW	F 36" X 12" CLERESTORY WINDOW

# 4 Window Types



Registration Seal

14 NE First Avenue STE 500 Miami FL 33132
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Issued/Revised

No Date Description

09-23-2021 Permit Set

Drawing Title

Door / Window Schedules

Scale As Noted

Date September 23, 2021

Drawn By RW

Project No. 17xxx

Drawing No.

A6.03