

ALL STRUCTURAL NOTATIONS AND OVERALL BUILDING DESIGN ARE TO BE REVIEWED BY A REGISTERED PROFESSIONAL / ENGINEER TO ENSURE THEY MEET LOCAL DESIGN LOADS, CODES AND SEISMIC REQUIREMENTS. UNTIL REVIEWED AND APPROVED, THESE DRAWINGS ARE TO BE CONSIDERED AS PRELIMINARY.

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# DESIGN LOADS (DOOR AND WINDOW HEADERS):

LIVE LOAD: 40 PSF DEAD LOAD: 15 PSF TOTAL LOAD: 65 PSF

ROOF LOADS:

LIVE LOAD: 28 PSF DEAD LOAD: 15 PSF

TOTAL LOAD: 43 PSF

ALL WINDOW AND DOOR HEADER SIZES ARE TO BE REVIEWED TO ENSURE THEY MEET LOCAL DESIGN LOADS AND ADHERE TO LOCAL BUILDING CODES

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A STRUCTURAL ENGINEER IS REQUIRED TO PROVIDE SEISMIC SOLUTIONS AND CERTIFY THIS DESIGN

UNDER THE REQUIREMENTS OF THE MOST CURRENT EDITION OF THE LOCAL RESIDENTIAL BUILDING CODES.

CONSULTANT

PROJECT

PROPOSED GARAGE ADDRESS: TBA

DISCLAIMER

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**ENGINEER'S SEAL** 

VANCOUVER DRAFTING

DAVID DOMOSLAI WWW.VANCOUVERDRAFTING.CA 604-722-2769 VANCOUVERDRAFTING@HOTMAIL.COM

SHEET TITLE

- ALL INTERIOR AND EXTERIOR FINISHING SHALL BE SPECIFIED BY THE OWNER

- FLASH AT ALL EXTERIOR CHANGES IN EXTERIOR FINISHING. CAULK AROUND ALL UNFLASHED EXTERIOR OPENINGS - SEE RAIN SCREEN DETAILS PROVIDED

- OPENINGS IN PARTITIONS WITHOUT DOORS ARE SHOWN AS FULL HEIGHT

- COAT CLOSETS SHALL HAVE ROAD AND SHELF. LINEN CLOSETS SHALL

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HAVE 5 ADJUSTABLE SHELVES.

**ERRORS & OMISSIONS:** 


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WITHIN THIS PLAN

FOUDNATION & GARAGE PLAN

JOB NO:
SCALE
DRAWN BY
DATE 2020-11-10

A-1

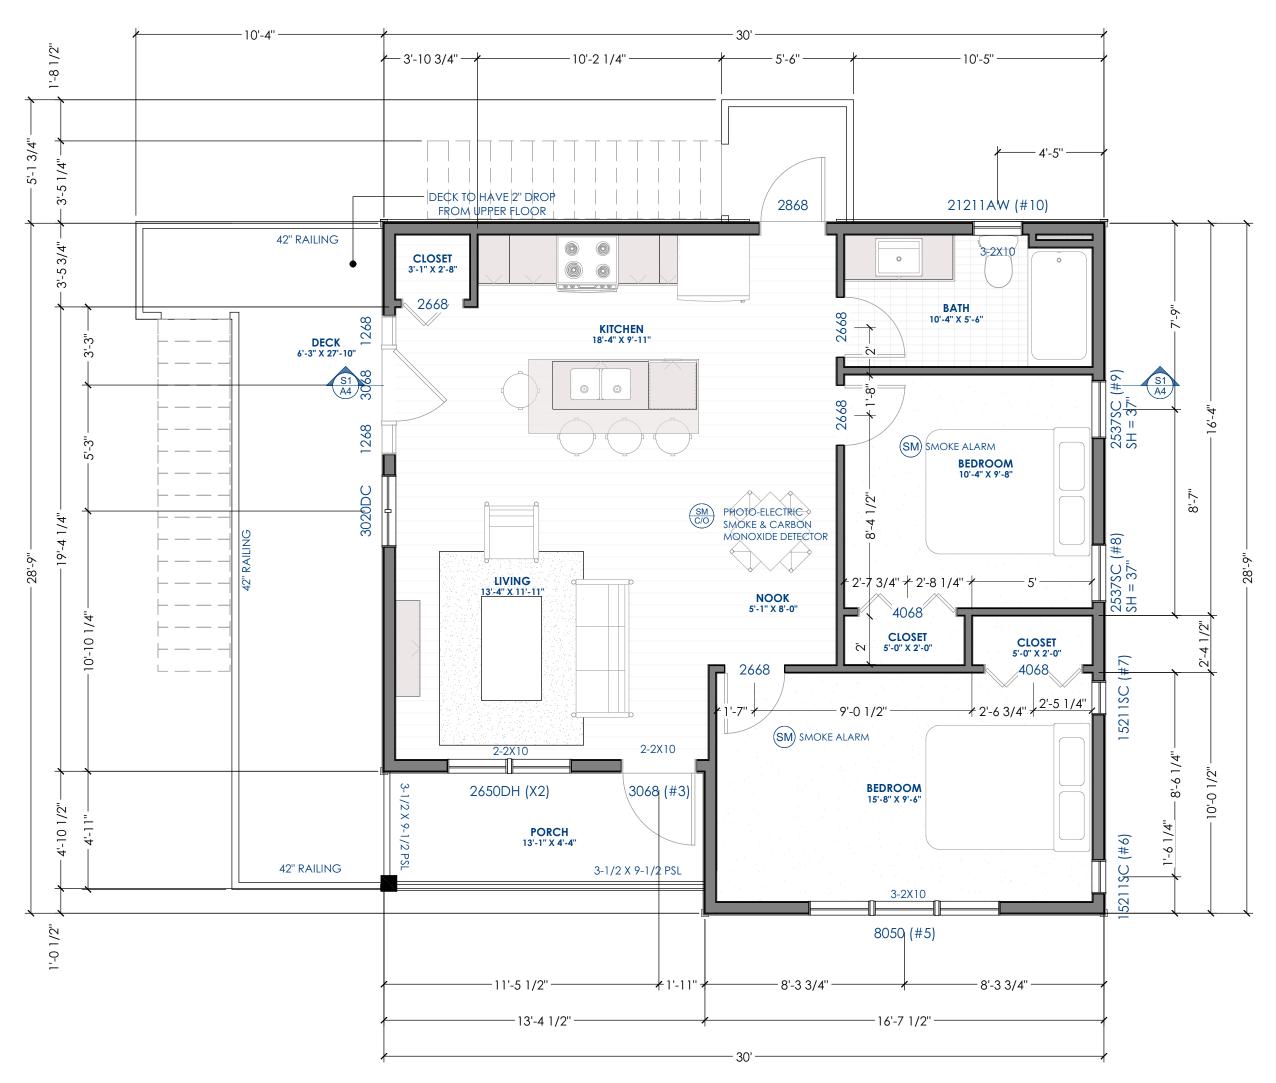

4 1/2 : 12 4 1/2 : 12 - - 4 172 : 12 -**ROOF PLAN** SCALE: 1/4" = 1'-0"

**UPPER FLOOR PLAN** SCALE: 1/4" = 1'-0" AREA (LIVABLE): 783 SQ FT AREA (DECK): 210 SQ FT TOTAL AREA: 993 SQ FT

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**CONSULTANT** 

**PROJECT** 

PROPOSED GARAGE ADDRESS: TBA

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# **VANCOUVER DRAFTING**

DAVID DOMOSLAI WWW.VANCOUVERDRAFTING.CA 604-722-2769 VANCOUVERDRAFTING@HOTMAIL.COM

SHEET TITLE

LOFT FLOOR PLAN

JOB NO: SCALE

DATE

**DRAWN BY** 2020-11-10

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FRONT ELEVATION SCALE: 1/4" = 1'-0" RIGHT ELEVATION SCALE: 1/4" = 1'-0"



REAR ELEVATION

SCALE: 1/4" = 1'-0"

LEFT ELEVATION SCALE: 1/4" = 1'-0"

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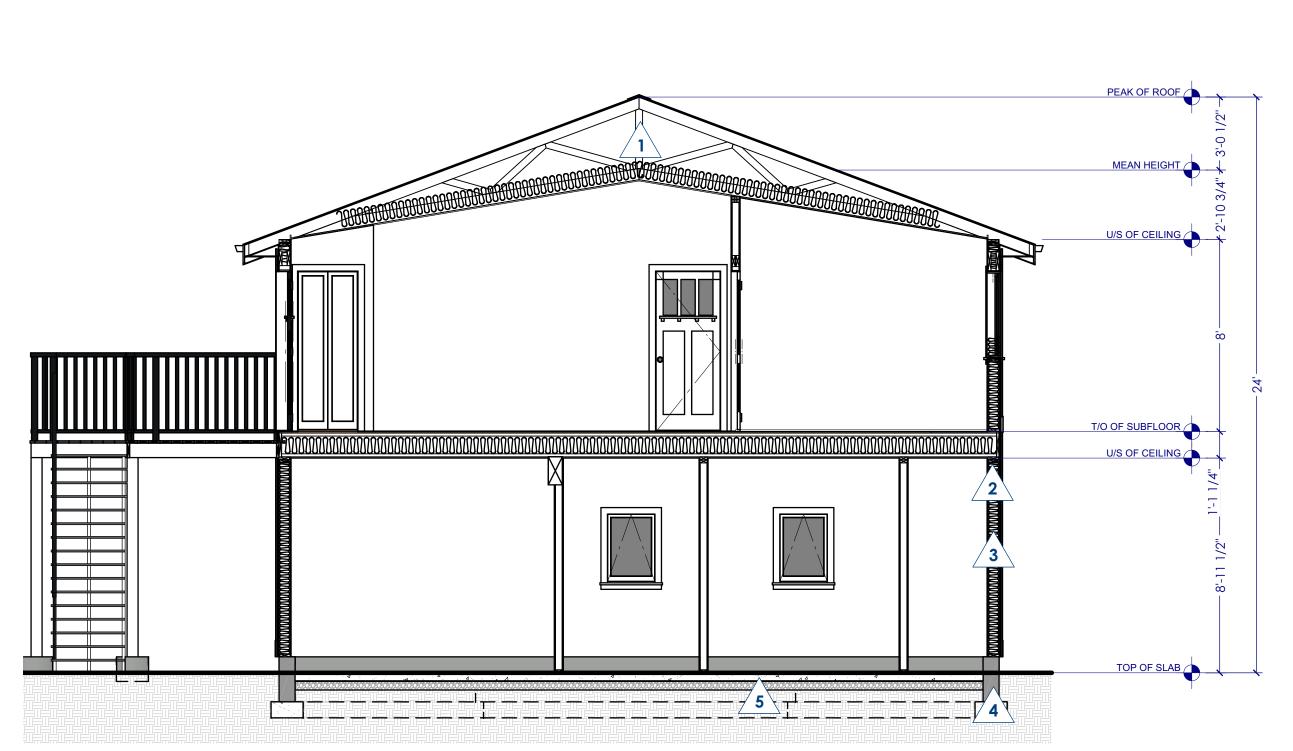
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JOB NO: SCALE DRAWN BY


DATE


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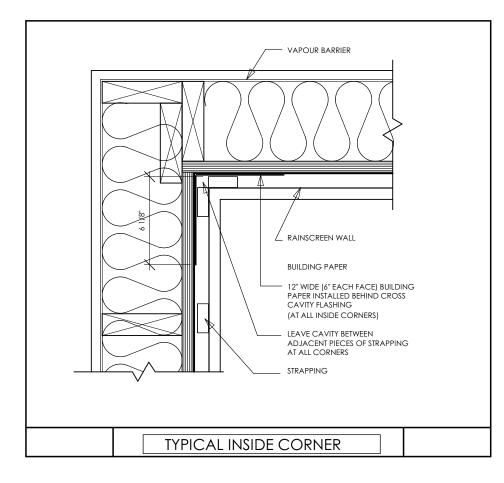
A-3





#### **CROSS SECTION S1** SCALE: 1/4" = 1'-0"




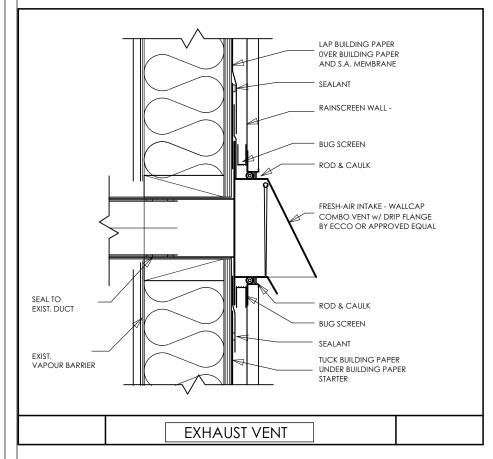


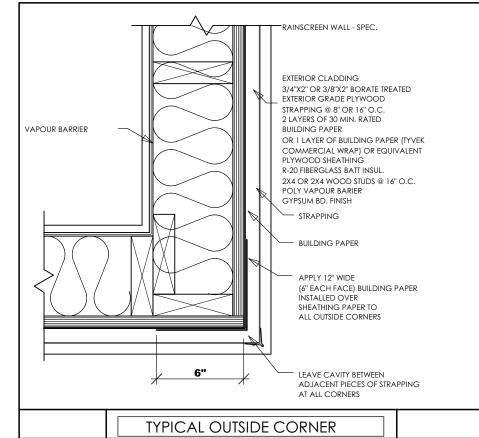


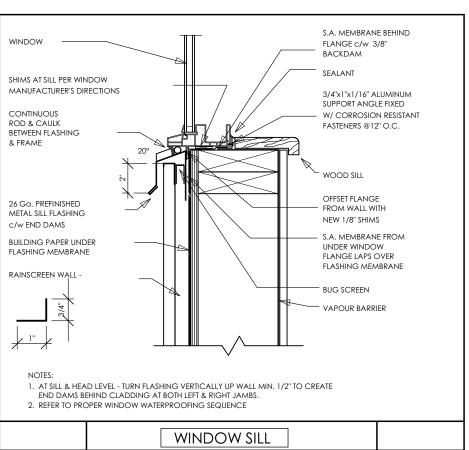


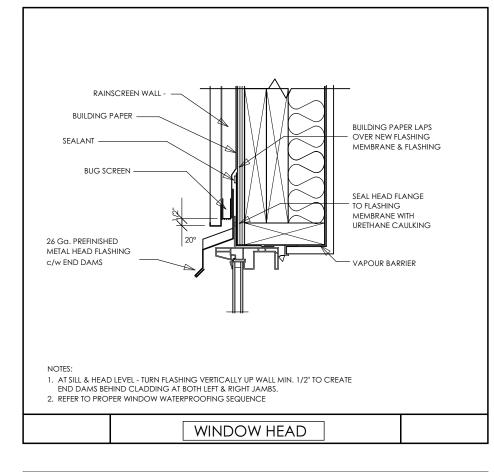

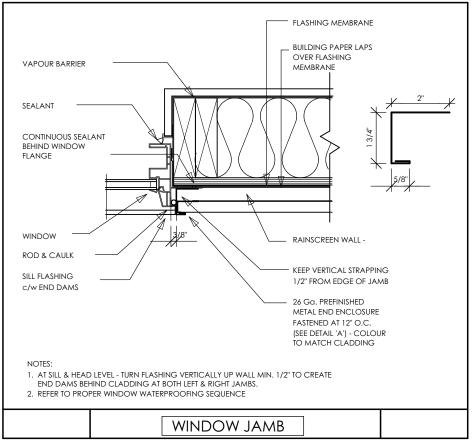

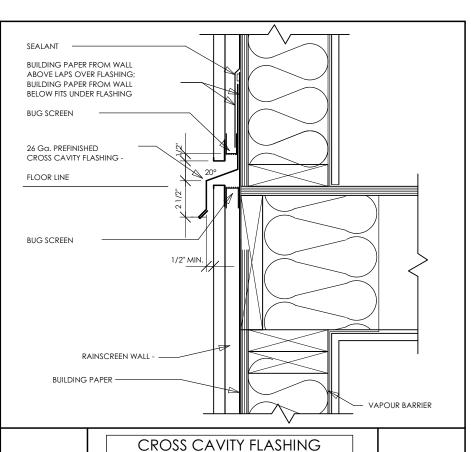

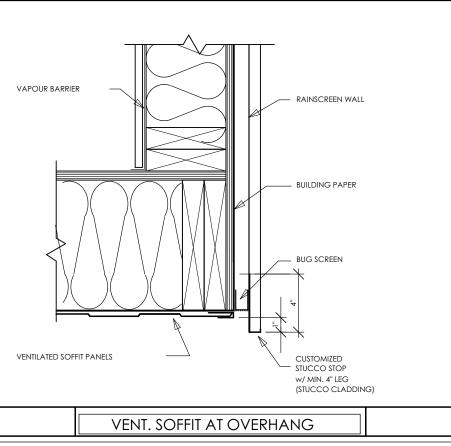

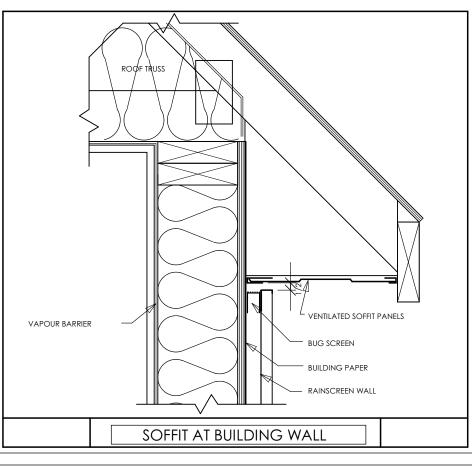

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# **TYPICAL SLOPED ROOF SYSTEM:**

- 35 YEAR ASPHALT SHINGLES C/W RIDGE CAP. INSTALL PER MANUF.'S RECOMMENDATIONS. COLOR AND STYLE TO BE SELECTED BY OWNERS -MIN 2 LAYERS LAPPED ROOFING PAPER C/W ICE-DAM PROTECTION. -MIN. 1/2 PLY. SHEATHING W/ H-CLIPS AS REQUIRED -ENGINEERED WOOD TRUSSES BY MANUFACTURER -MIN. R-44 INSULATION (BATT OR BLOWN) CONFIRM W/ OWNERS -6 MIL POLY V.B. C/W LAP & TAPED JOINTS. -5/8" DRYWALL OR PER OWNERS SPECIFICATIONS -SPRAYED PAINT FINISH OR PER OWNERS SPECIFICATIONS

#### TYPICAL LOAD BEARING WALL

- 1/2" DRYWALL - 2X4 OR 2X6 STUD WALL - STUDS @ 16" O.C. (UNLESS OTHERWISE NOTED)

> 1/2" DRYWALL - PAINT FINISHED E.S. OR PER OWNERS SPECIFICATIONS

**TYPICAL EXTERIOR WALL:** -2X6 STUDS @ 16" O.C. UNLESS NOTED OTHERWISE -MIN. 2 LAYERS OF 30 LAPPED BUILDING PAPER -1/2" PLY SHEATHING -FILL CAVITY W/ BATT OR BLOWN INSULATION MIN. R20 -6 MIL. POLY V.B. -1/2" DRYWALL

-PAINT FINISH OR PER OWNERS SPECIFICATIONS

#### **CONCRETE FOUNDATION WALL:**

- BITUMINOUS DAMPROOFING - MIN. 2 COATS - 8" CONCRETE FOUNDATION WALL C/W 15M @ 16" O.C. VERT & HORIZ KEEP REINFORCED 1-1/2" CLEAR FROM INSIDE WALL FACE - 2'-0" X 8" CONCRETE STRIP FOOTING C/W/ 3-15M BOT. CONT. UNDISTURBED SOIL BEARING


- 4" Perimeter Drain W/ Min. 12" Gravel Cover or to suit site cond.

#### **GARAGE FLOOR - SLAB ON GRADE 5**

- FINISH BY OWNER - 4" CONCRETE SLAB COMPACTED GRANULAR FILL MIN. 1% SLOPE TO ENTRY

**UPPER FLOOR SYSTEM:** -FINISH BY OWNER -3/4" SUBFLOOR T&G -11-7/8" TJI ENGINEERED FLOOR JOISTS

1/2" DRYWALL

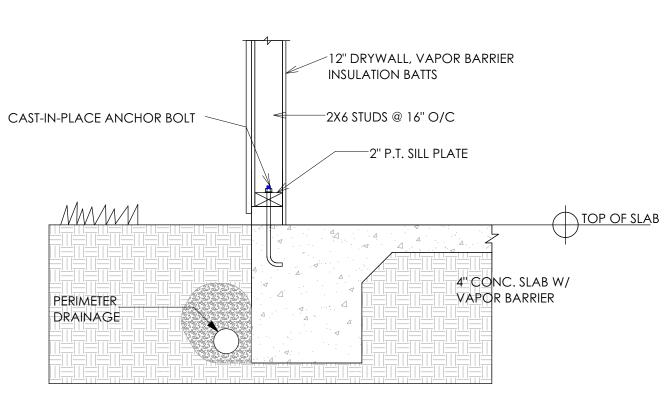

#### OPTIONAL MONO SLAB FOUNDATION SCALE: NTS

SHEATHING/SIDING 2X6 STUDS @ 16" O.C. 2X6 TREATED SIL PLATE - 1" EXPANSION JOINT - 4" CONCRETE SLAB - REINFORCING WIRE FABRIC CAST-IN-PLACE ANCHOR BOLT VAROR BARRIER PERIMETER DRAINAGE CONCRETE FOUNDATION CONCRETE FOOTING

CONCRETE SLAB AT FOUNDATION WALL

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**CROSS SECTION & DETAILS** 

JOB NO: SCALE **DRAWN BY** 2020-11-10 DATE